SHELL BUILDING

3872027 SUNRISE PLAZA DR. CLERMONT, FL

2018021467

LANS FOR INSPECTORS USE ONLY BLDG \$ 4/27/18 \$


TRUCTION FLORIDA AND A DR

HOWIES SUNRISE HUNGRY 3872027

FEB. 13, 2018 ADC /1\ MAR. 26, 2018 2 MAY. 01, 2018 3 JUNE 12, 2018 17-265

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BUILDING CLASSIFICATION AND DATA SITE LOCATION MAP

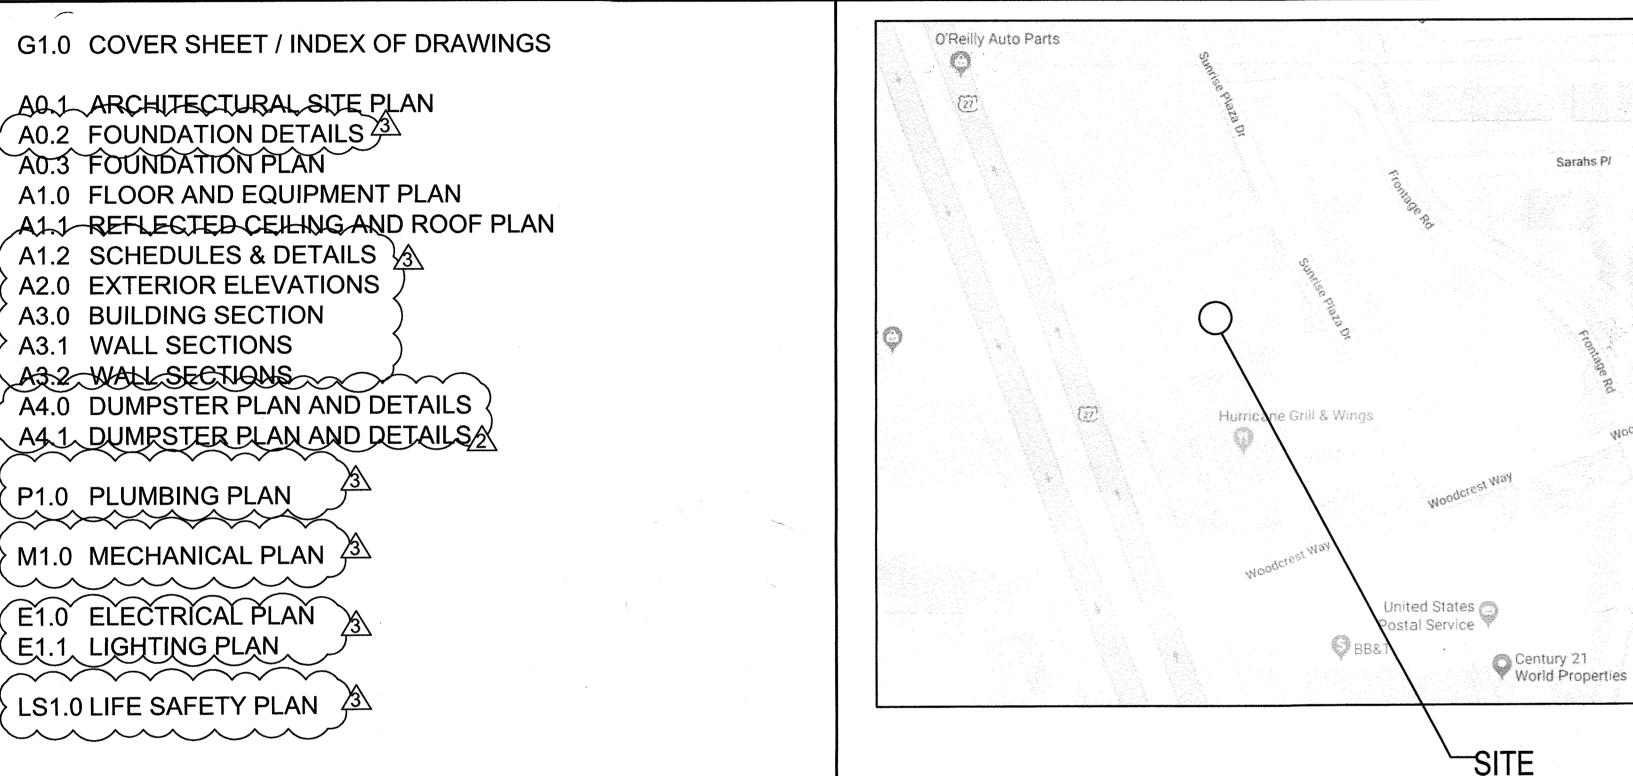

INDEX OF DRAWINGS

APPLICABLE CODES:

LOCATION MAP SCALE: NTS 3872027 SUNRISE PLAZA DR. CLERMONT, FLORIDA

FLORIDA BUILDING CODE, BUILDING (FBC-B) **6TH EDITION 6TH EDITION** FLORIDA ACCESSIBILITY CODE (FAC) FLORIDA BUILDING CODE, MECHANICAL (FBC-M) **6TH EDITION** FLORIDA BUILDING CODE, PLUMBING (FBC-P) **6TH EDITION** FLORIDA BUILDING CODE, EXISTING BUILDING (FBC-EB) **6TH EDITION** FLORIDA FIRE PREVENTION CODE (FFPC) **6TH EDITION** NATIONAL ELECTRICAL CODE (NEC) 2014 EDITION **OCCUPANCY GROUP CLASSIFICATION:**

TO BE DETERMINED (REFER TO TENANT BUILD OUT COVER SHEET)

TYPE OF CONSTRUCTION: **NEW CONSTRUCTION TYPE V-B**

AREA CALCULATIONS: AREA OF ALTERATION: 2,613SF+/-)

PRODUCT APPROVAL:

THE CONTRACTOR SHALL MAKE AVAILABLE TO THE BUILDING INSPECTOR ANY DOCUMENTATION NECESSARY TO VERIFY THAT ALL PRODUCTS REQUIRING APPROVAL PER FS 553.842 ARE IN COMPLIANCE.

ACCESSIBILITY:

THIS PROJECT HAS BEEN DESIGNED TO COMPLY WITH 2017 FLORIDA ACCESSIBILITY CODE 6TH EDITION IN THE TENANT SUITE.

WIND LOAD:

WIND SPEED 130 (PER SECTION 1609, FIGURE 1609.3(1), 2017 FLORIDA BUILDING CODE)


☆DEGREE OF SHELL COMPLETION

FOOTINGS NO SLAB EXTERIOR WALL FINISH EXTERIOR ONLY ROOF STRUCTURE AND ROOF CURBS NO ELECTRIC, PLUMBING OR MECHANICAL.

PLANS FOR INSPECTORS USE ONLY MUST BE ON JOB SITE DURING INSPECTION

2018021467

2018050002 JUN 2 2018

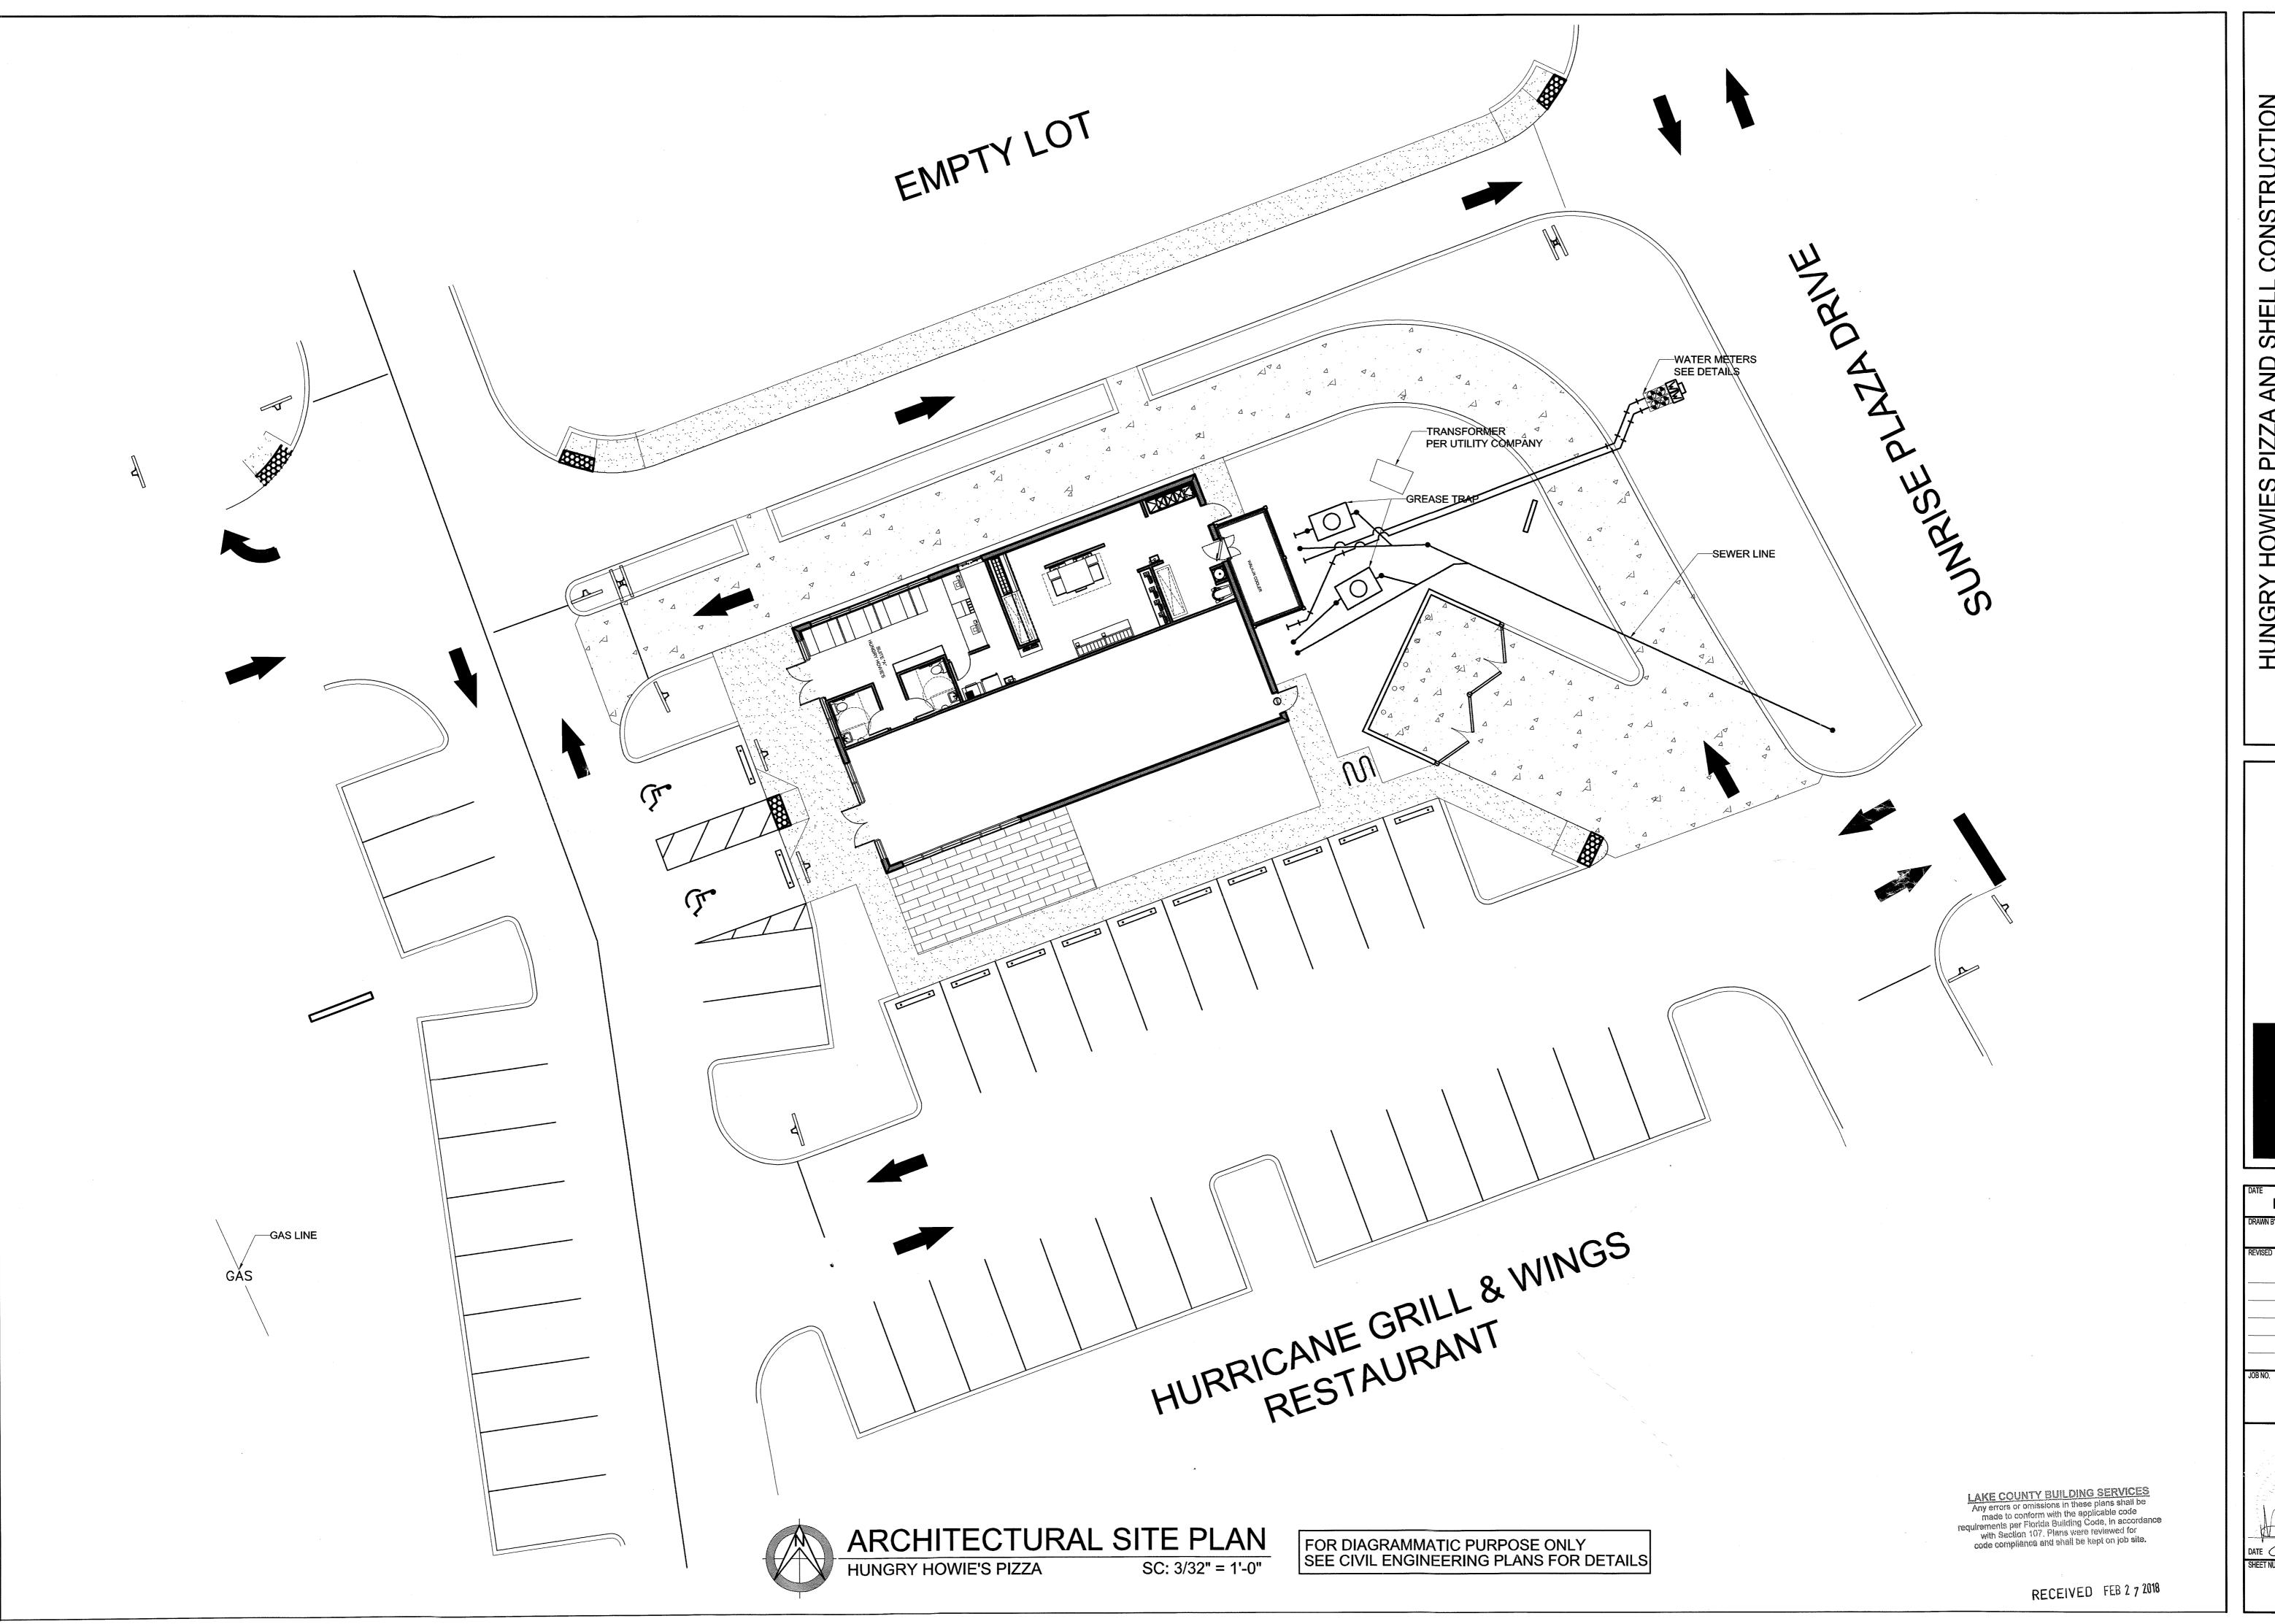

HUNGRY HOWIES PIZZA AND SHELL CONSTRUCTION 3872027 SUNRISE PLAZA DR., CLERMONT, FLORIDA

ARCHITECTURAL SITE PLAN

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FEB. 13, 2018

DRAWN BY

ADC

REVISED

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DATE 02/16/2018
SHEET NUMBER

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ALL CONSTRUCTION SHALL COMPLY WITH THE 2017 FLORIDA BUILDING CODE.

THE CONTRACTOR SHALL FINISH GRADE AROUND THE FOUNDATION TO PROVIDE POSITIVE WATER DRAINAGE AWAY FROM THE FOUNDATION, AND PREVENT THE DETENTION OF WATER. THE FINISHED GRADE IS TO BE GRADED AWAY FROM A FOUNDATION AT A MINIMUM RATE OF SIX INCHES OF FALL WITHIN THE FIRST TEN FEET. AN EXCEPTION EXISTS THAT IF LOT LINES, SLOPES, WALLS OR OTHER PHYSICAL BARRIERS PROHIBIT THE SIX INCHES OF FALL WITHIN TEN FEET; THEN DRAINS OR SWALES SHALL BE PROVIDED TO ENSURE DRAINAGE AWAY FROM THE

- CONCRETE = 3,000 PSI CONCRETE AIR ENTRAINED. TOTAL AIR CONTENT (PERCENT BY VOLUME OF CONCRETE) SHALL NOT BE LESS THAN 5 PERCENT OR MORE THAN 7 PERCENT. THIS DETERMINATION SHALL BE AT THE DISCRETION OF THE GOVERNING INSPECTOR.

- STEEL = 60 KSI

- FILL MATERIAL COMPACTION = 95% OF MAX. DRY DENSITY AS DETERMINED BY MOD. PROCTOR

NOTE: COMPACTION TEST SHALL NOT BE REQUIRED WHEN FILL IS LESS THAN 12 INCHES IN DEPTH. THIS DETERMINATION SHALL BE AT THE DISCRETION OF THE GOVERNING INSPECTOR.

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PLEASE NOTE THAT EVEN WITH THE PLACEMENT OF CONTROL JOINTS
SOME AESTHETIC HAIRLINE CRACKS MAY STILL FORM WITHIN THE SLAB.

SOILS ARE TO BE TREATED CHEMICALLY FOR TERMITES.

CONTRACTOR TO VERIFY ALL DIMENSIONS & SPECIFICATIONS FOR FOUNDATION PLAN PRIOR TO CONSTRUCTION. THE LOCATION AND QUANTITY OF FLOOR OUTLETS, CONDUITS, AND OTHER FOUNDATION PENETRATIONS SHALL BE VERIFIED AND THE RESPONSIBILITY OF THE CONTRACTOR PRIOR TO POURING THE SLAB.

FOOTINGS SHALL HAVE A MINIMUM OF 30 INCHES OF CLEAN COMPACTED NATURAL OCCURRING SOIL THAT IS FREE OF MULCH, ORGANIC MATERIALS, EXPANSIVE SOIL, AND CONSISTS OF AT LEAST FIFTY PERCENT SAND. ANY ORGANIC MATERIAL LOCATED UNDER THE FOUNDATION SHALL BE REMOVED PRIOR TO CONSTRUCTION AND REPLACED WITH CLEAN COMPACTED SAND IN COMPLIANCE WITH NOTE 4 UNLESS OTHERWISE SPECIFIED. WHERE THE MINIMUM OF 30 INCHES OF CLEAN COMPACTED NATURAL OCCURRING SOIL CANNOT BE ACHIEVED THE SOIL SHALL BE REMOVED AND A MINIMUM OF 18 INCHES CLEAN COMPACTED SAND SHALL BE PLACED UNDER BOTH THE INTERNAL AND EXTERIOR FOOTINGS. IN EITHER CASE THE MATERIAL UNDER THE FOOTING SHALL HAVE A MINIMUM BEARING CAPACITY OF 2,000 PSF.

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TOP OF FOOTING REPRESENTS TOP OF FOOTING REFERENCED FROM FINISH FLOOR (0'-0" REF.) VERIFY WITH FINISHED GRADES SHOWN ON CIVIL DRAWINGS.

PARTIAL GEO-TECHNICAL INVESTIGATION - SEE FULL REPORT BY UNIVERSAL ENGINEERING SCIENCE DATED 07-11-2007

UNIVERSAL ENGINEERING SCIENCE PROJECT NO.: 01-0020803-001-01 REPORT NO.: 586211 REPORT DATE: JULY 11, 2007

BEARING PRESSURE

THE MAXIMUM ALLOWABLE BEARING PRESSURE FOR SHALLOW FOUNDATIONS UNDER THE ASSUMED MAXIMUM LOADS SHOULD NOT EXCEED 3,000 POUNDS PER SQUARE FOOT (PSF). PER SECTION 1805.4.1 OF THE FLORIDA BUILDING CODE (FLBC), THE FOUNDATIONS SHOULD BE DESIGNED FOR MOST UNFAVORABLE EFFECTS DUE TO THE COMBINATIONS OF LOADS SPECIFIED IN SECTION 1605.3 OF THE FLBC.


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HUNGRY HOWIES PIZZA

SC: 1/2" = 1'-0"


EXPANSION JOINT-CONTINUOUS ----3' BRICK VENEER NO. 4 BAR AT 48" O.C. HOOKED INTO FOOTING AND EXTEND TO TOP -4" PARTITION TIE BEAM. POUR SOLID WITH CONCRETE.-SUPPORT BRICK 6 X 6X 10/10 W.W.F. OVER PAVEMENT SEE CIVIL 6 MIL VAPOR BARRIER. CONCRETE SLAB.

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FOUNDATION DETAILS

HUNGRY HOWIES PIZZA

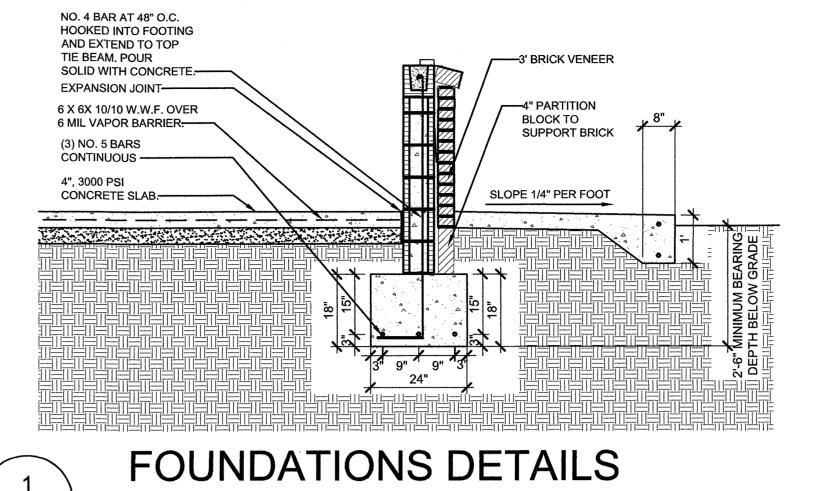SC: 1/2" = 1'-0"

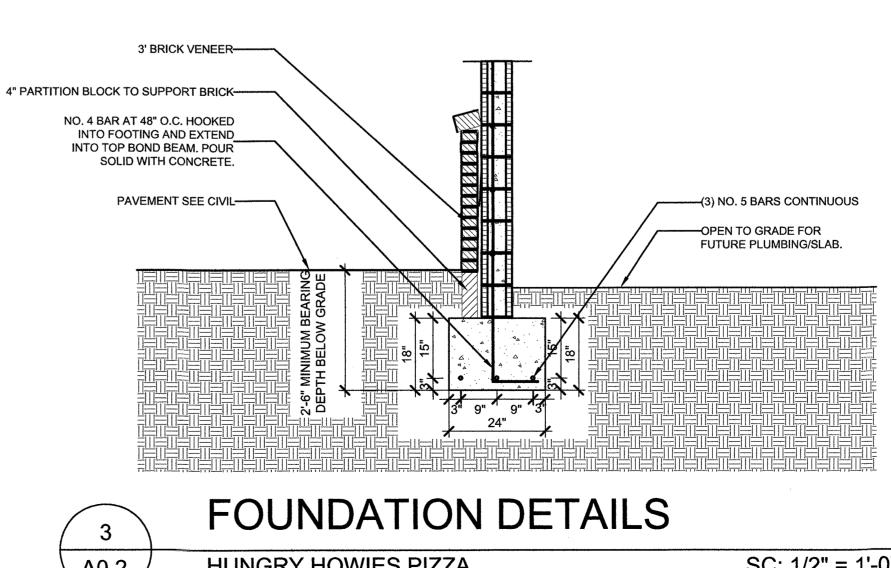

HUNGRY HOWIES PIZZA

SC: 1/2" = 1'-0"

RECEIVED JUN 2 1 2018

SHELL CONST., CLERMONT,

FEB. 13, 2018

/1\ MAR. 26, 2018 3 JUNE 12, 2018

17-265

DATE 06-12-2018

IN THE EVENT OF A CONFLICT BETWEEN THE PLANS AND GOVERNING BUILDING CODES AND STANDARDS, THE GOVERNING CODES AND STANDARDS SHALL GOVERN, AND THE ENGINEER OF RECORD SHALL BE NOTIFIED OF CONFLICT.

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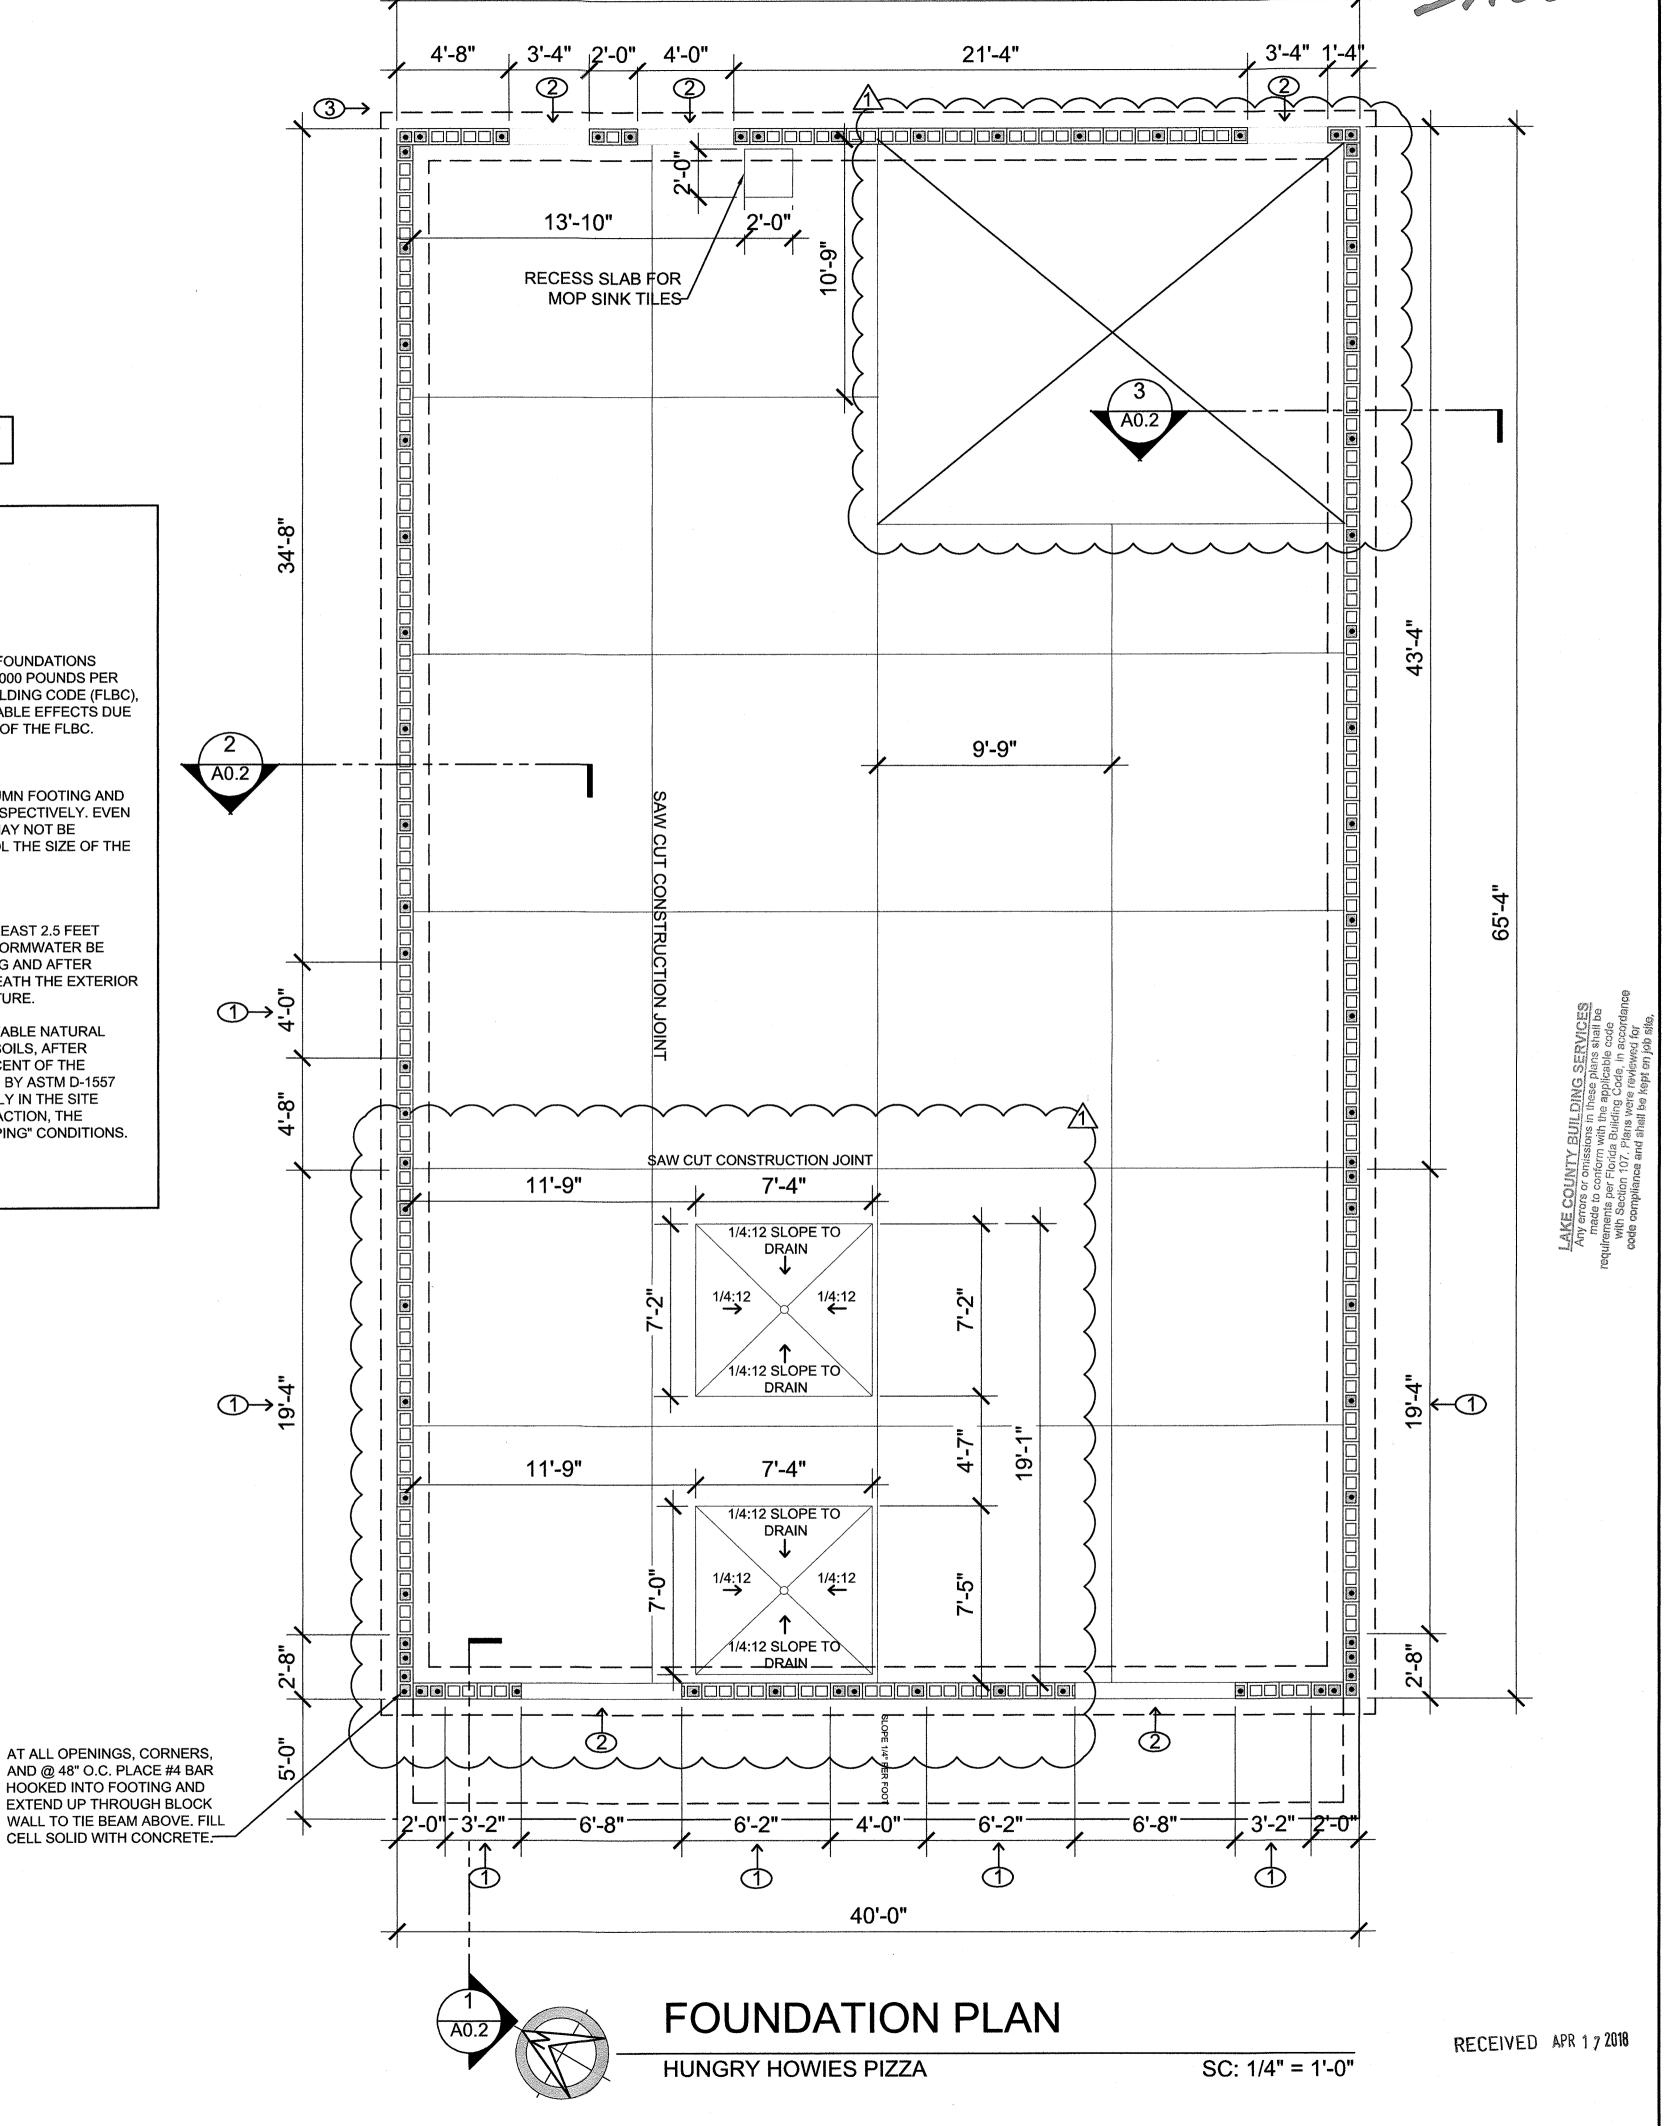
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FOUNDATION LEGEND

WINDOW OPENING ABOVEDOOR OPENING

3 2'-0" FOOTING BELOW GRADE



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FEB. 13, 2018

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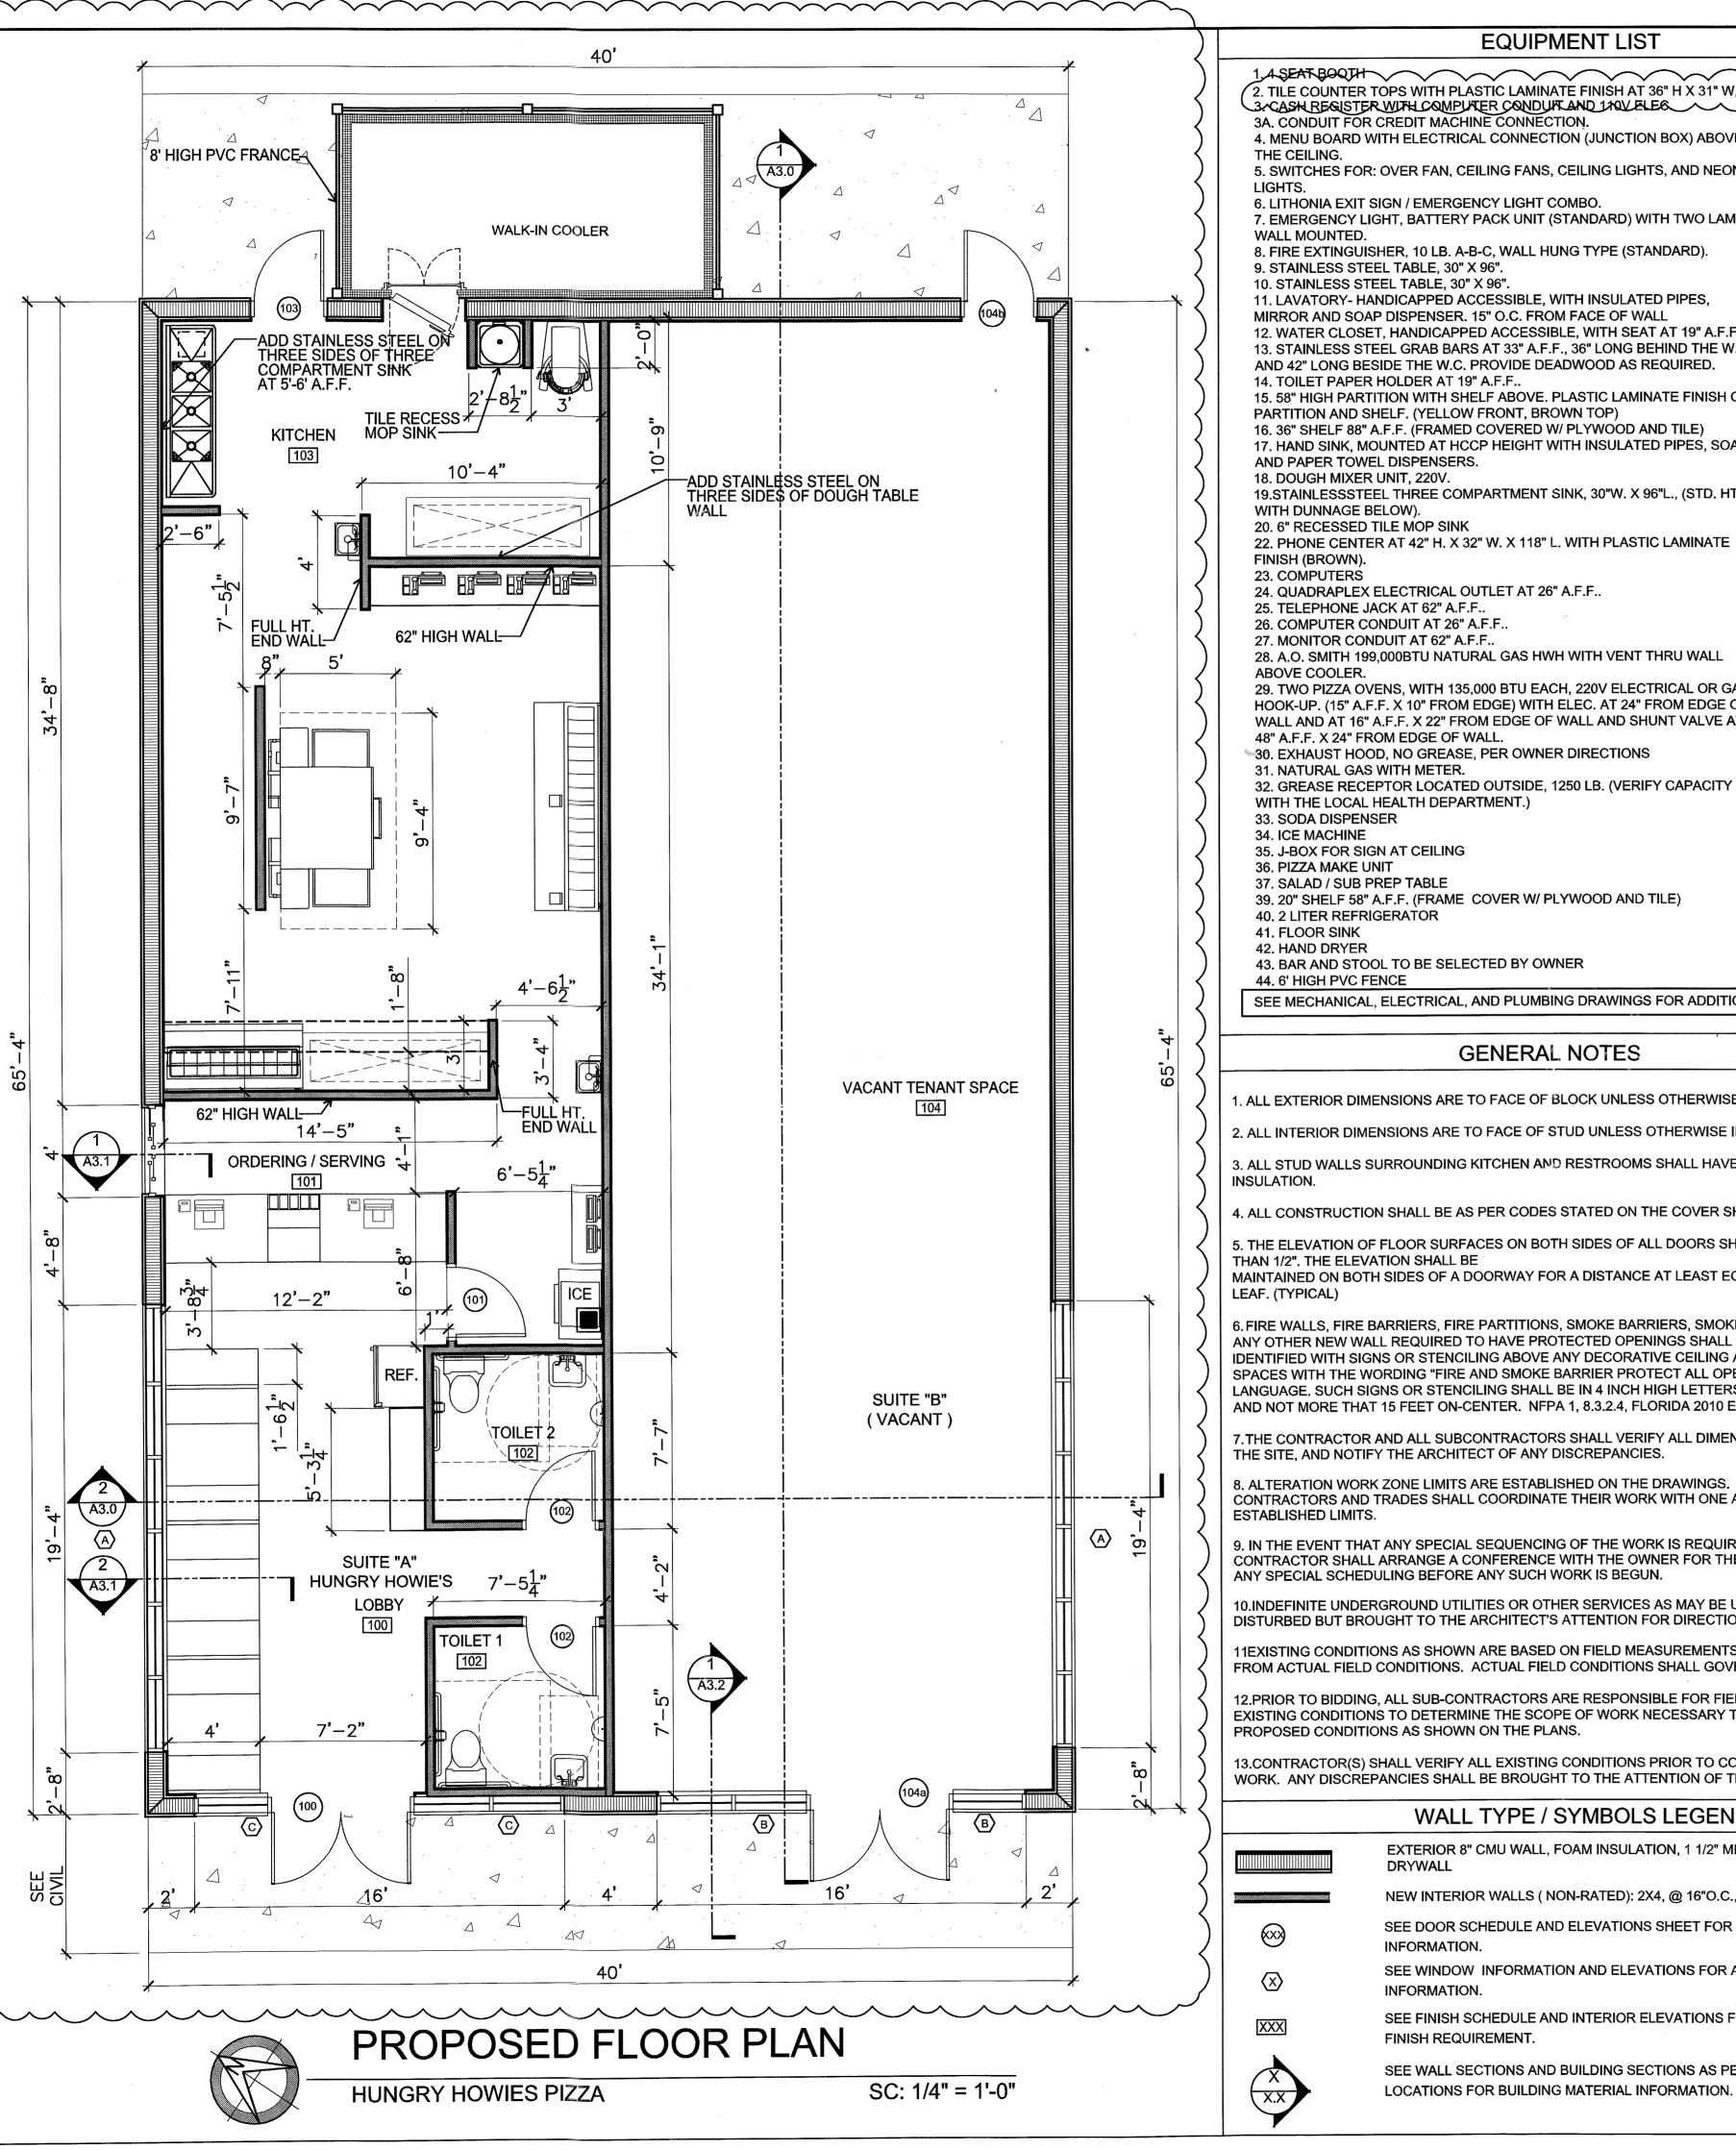
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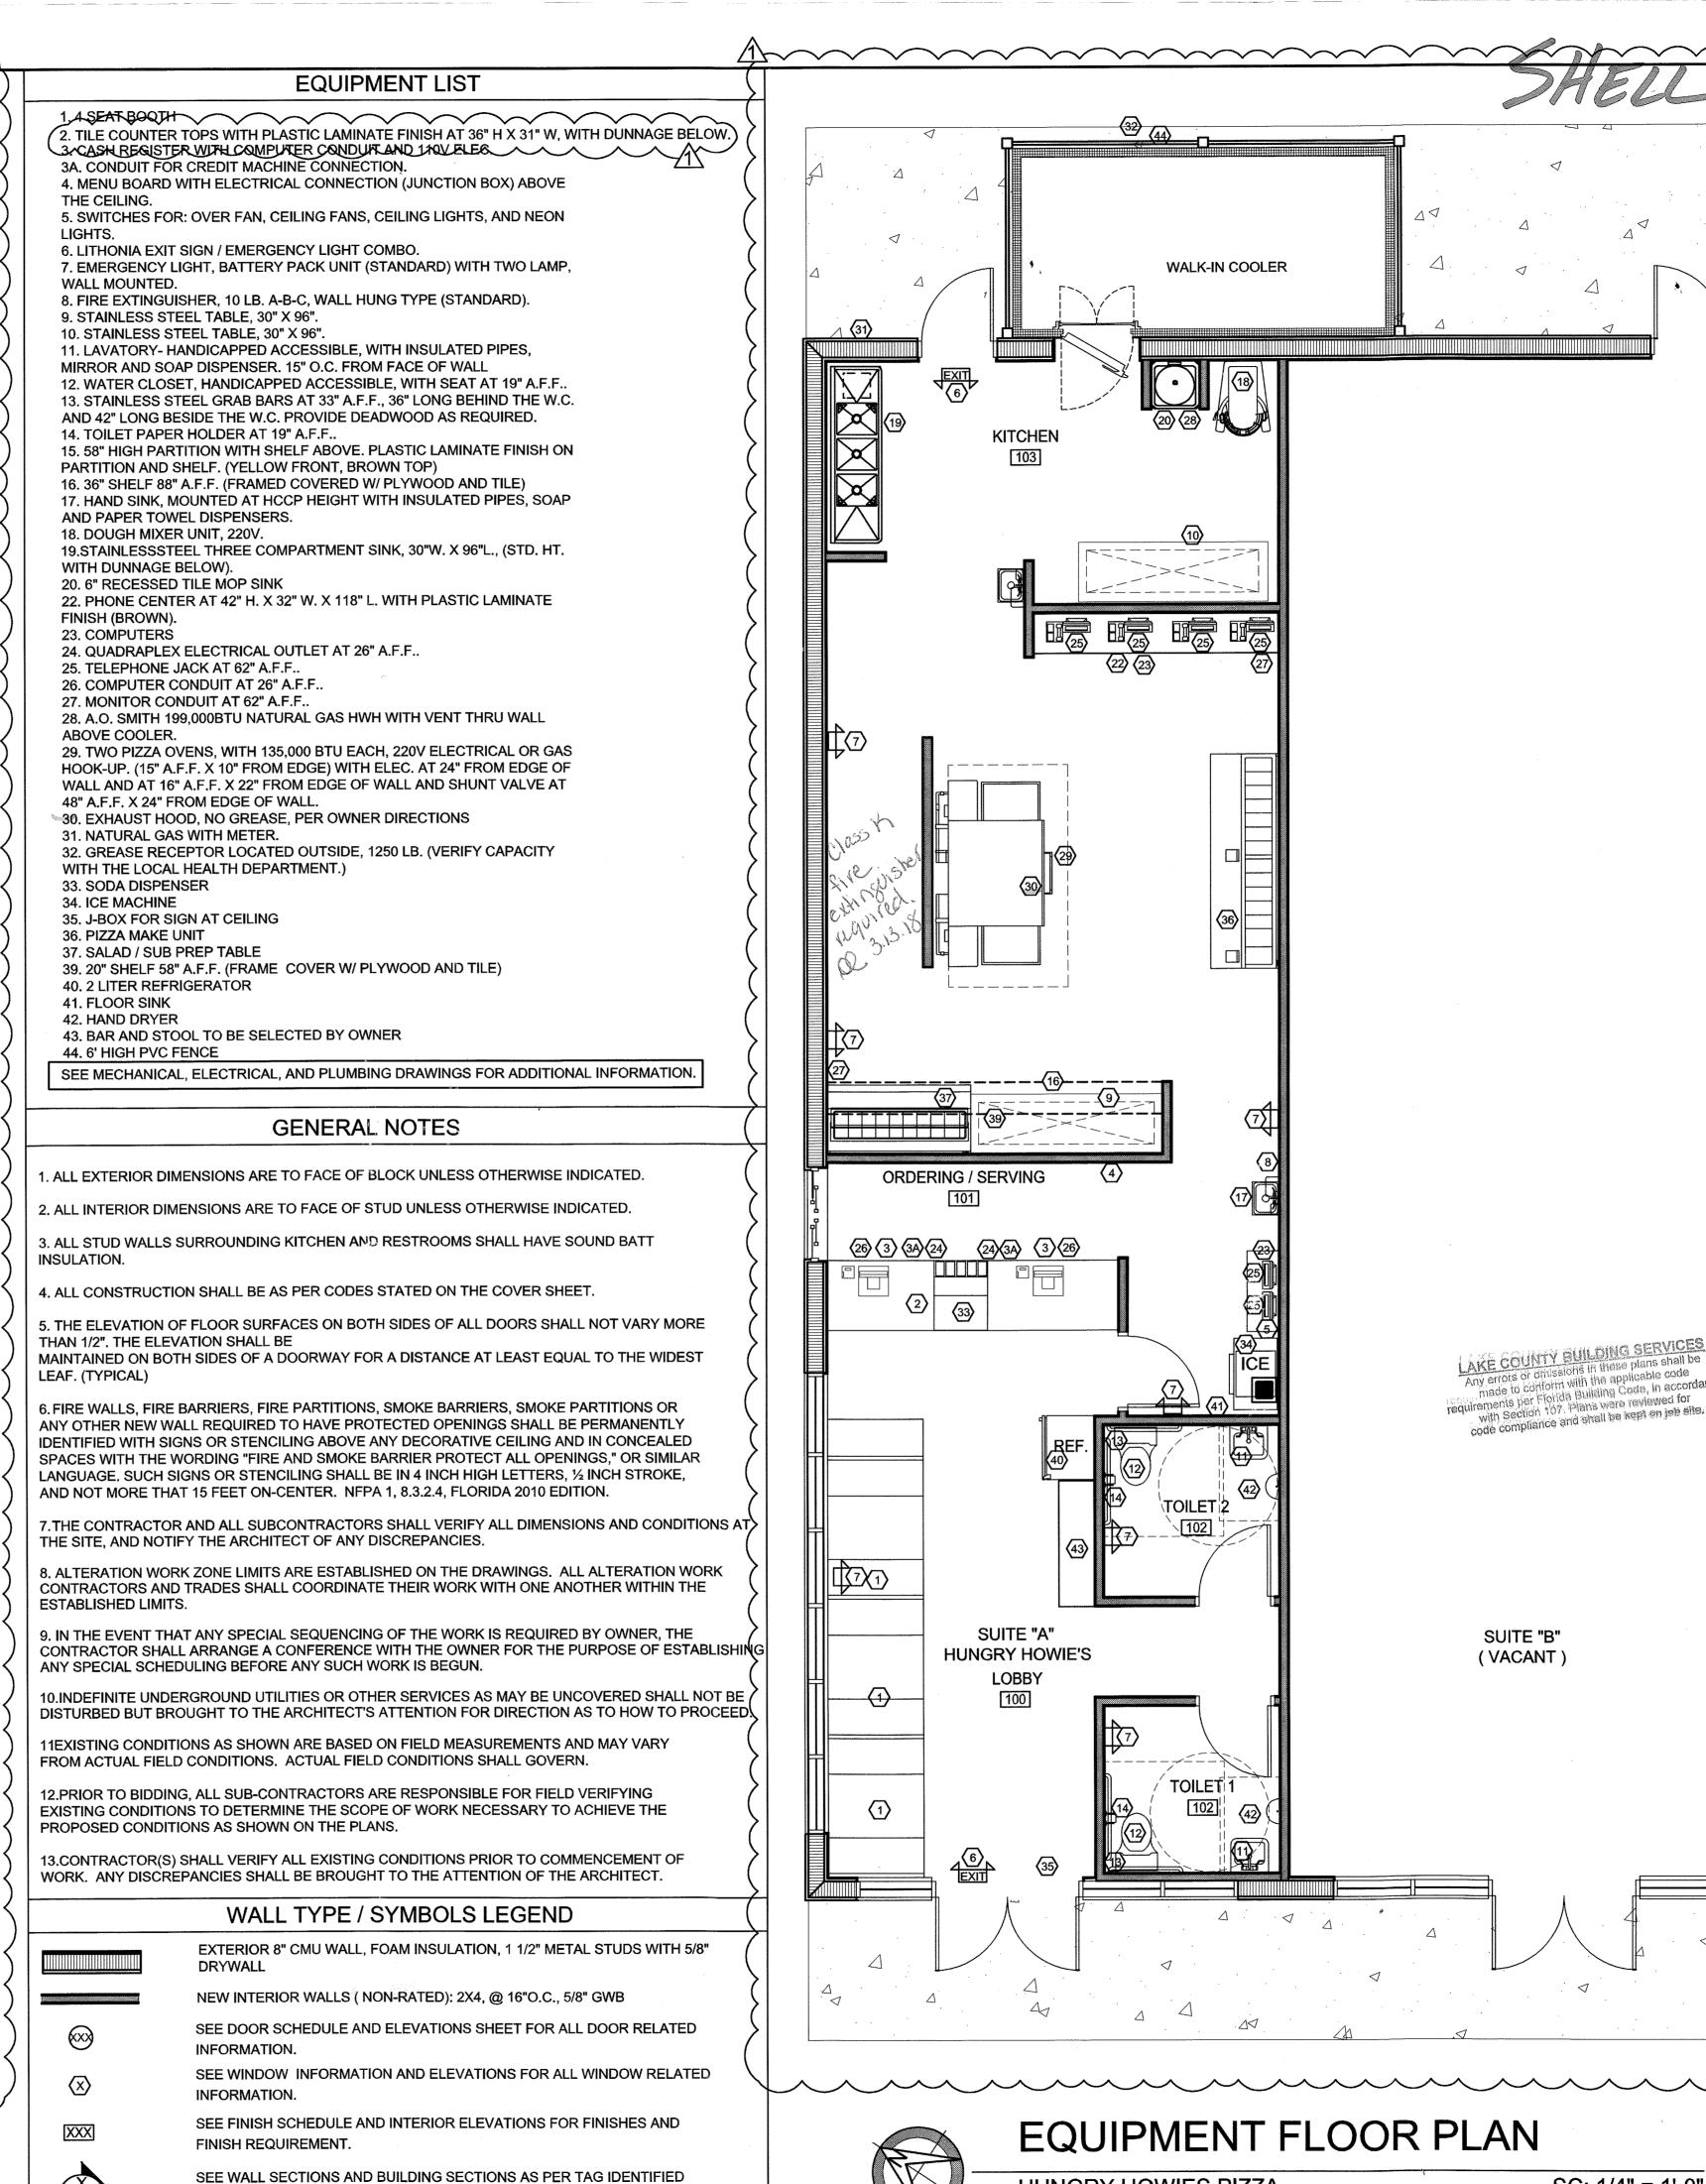
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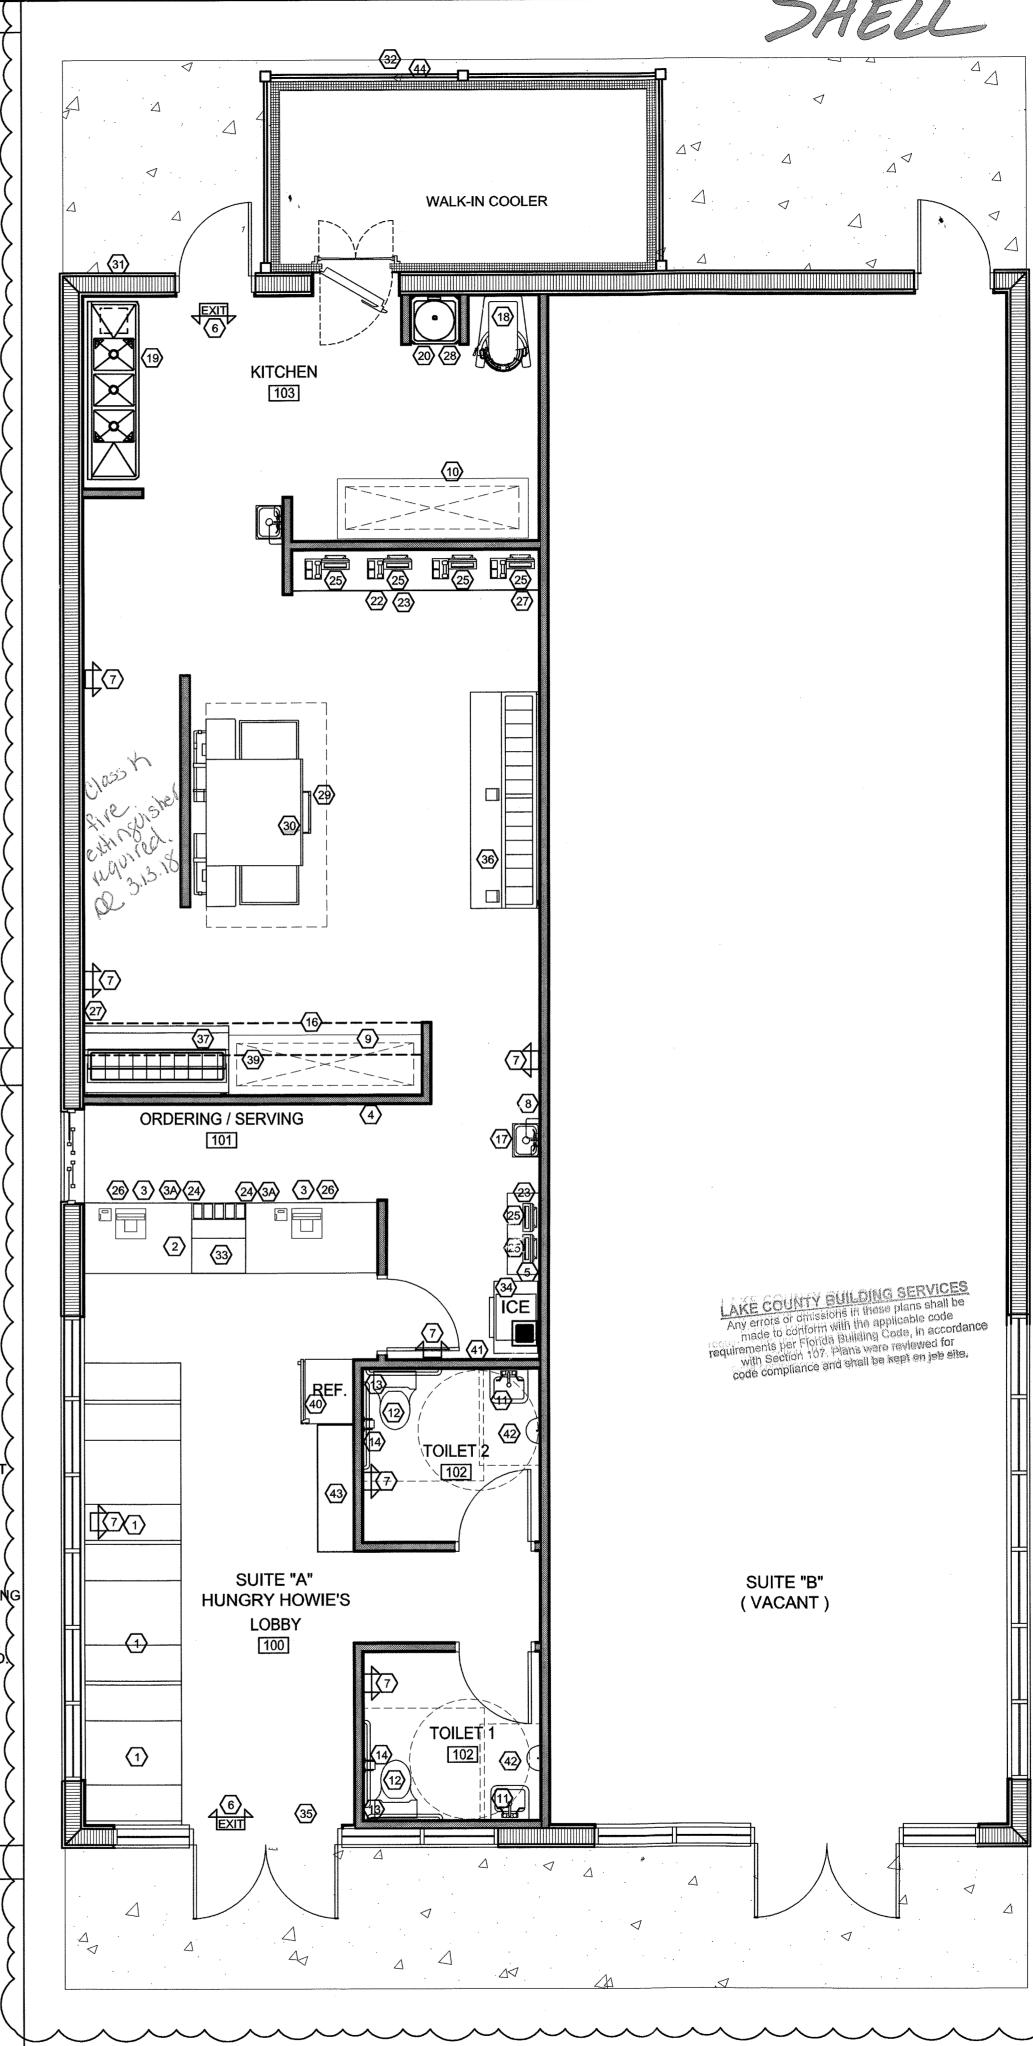
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EQUIPMENT FLOOR PLAN

HUNGRY HOWIES PIZZA


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SC: 1/4" = 1'-0"




HOWIES PIZZ SUNRISE PLA


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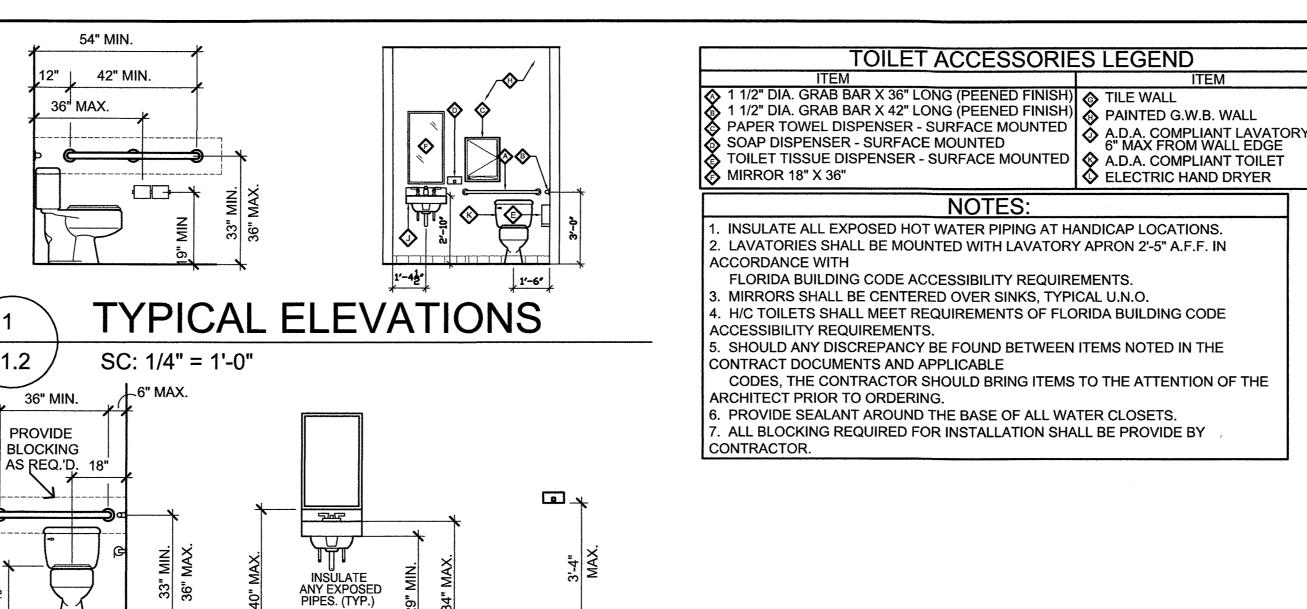




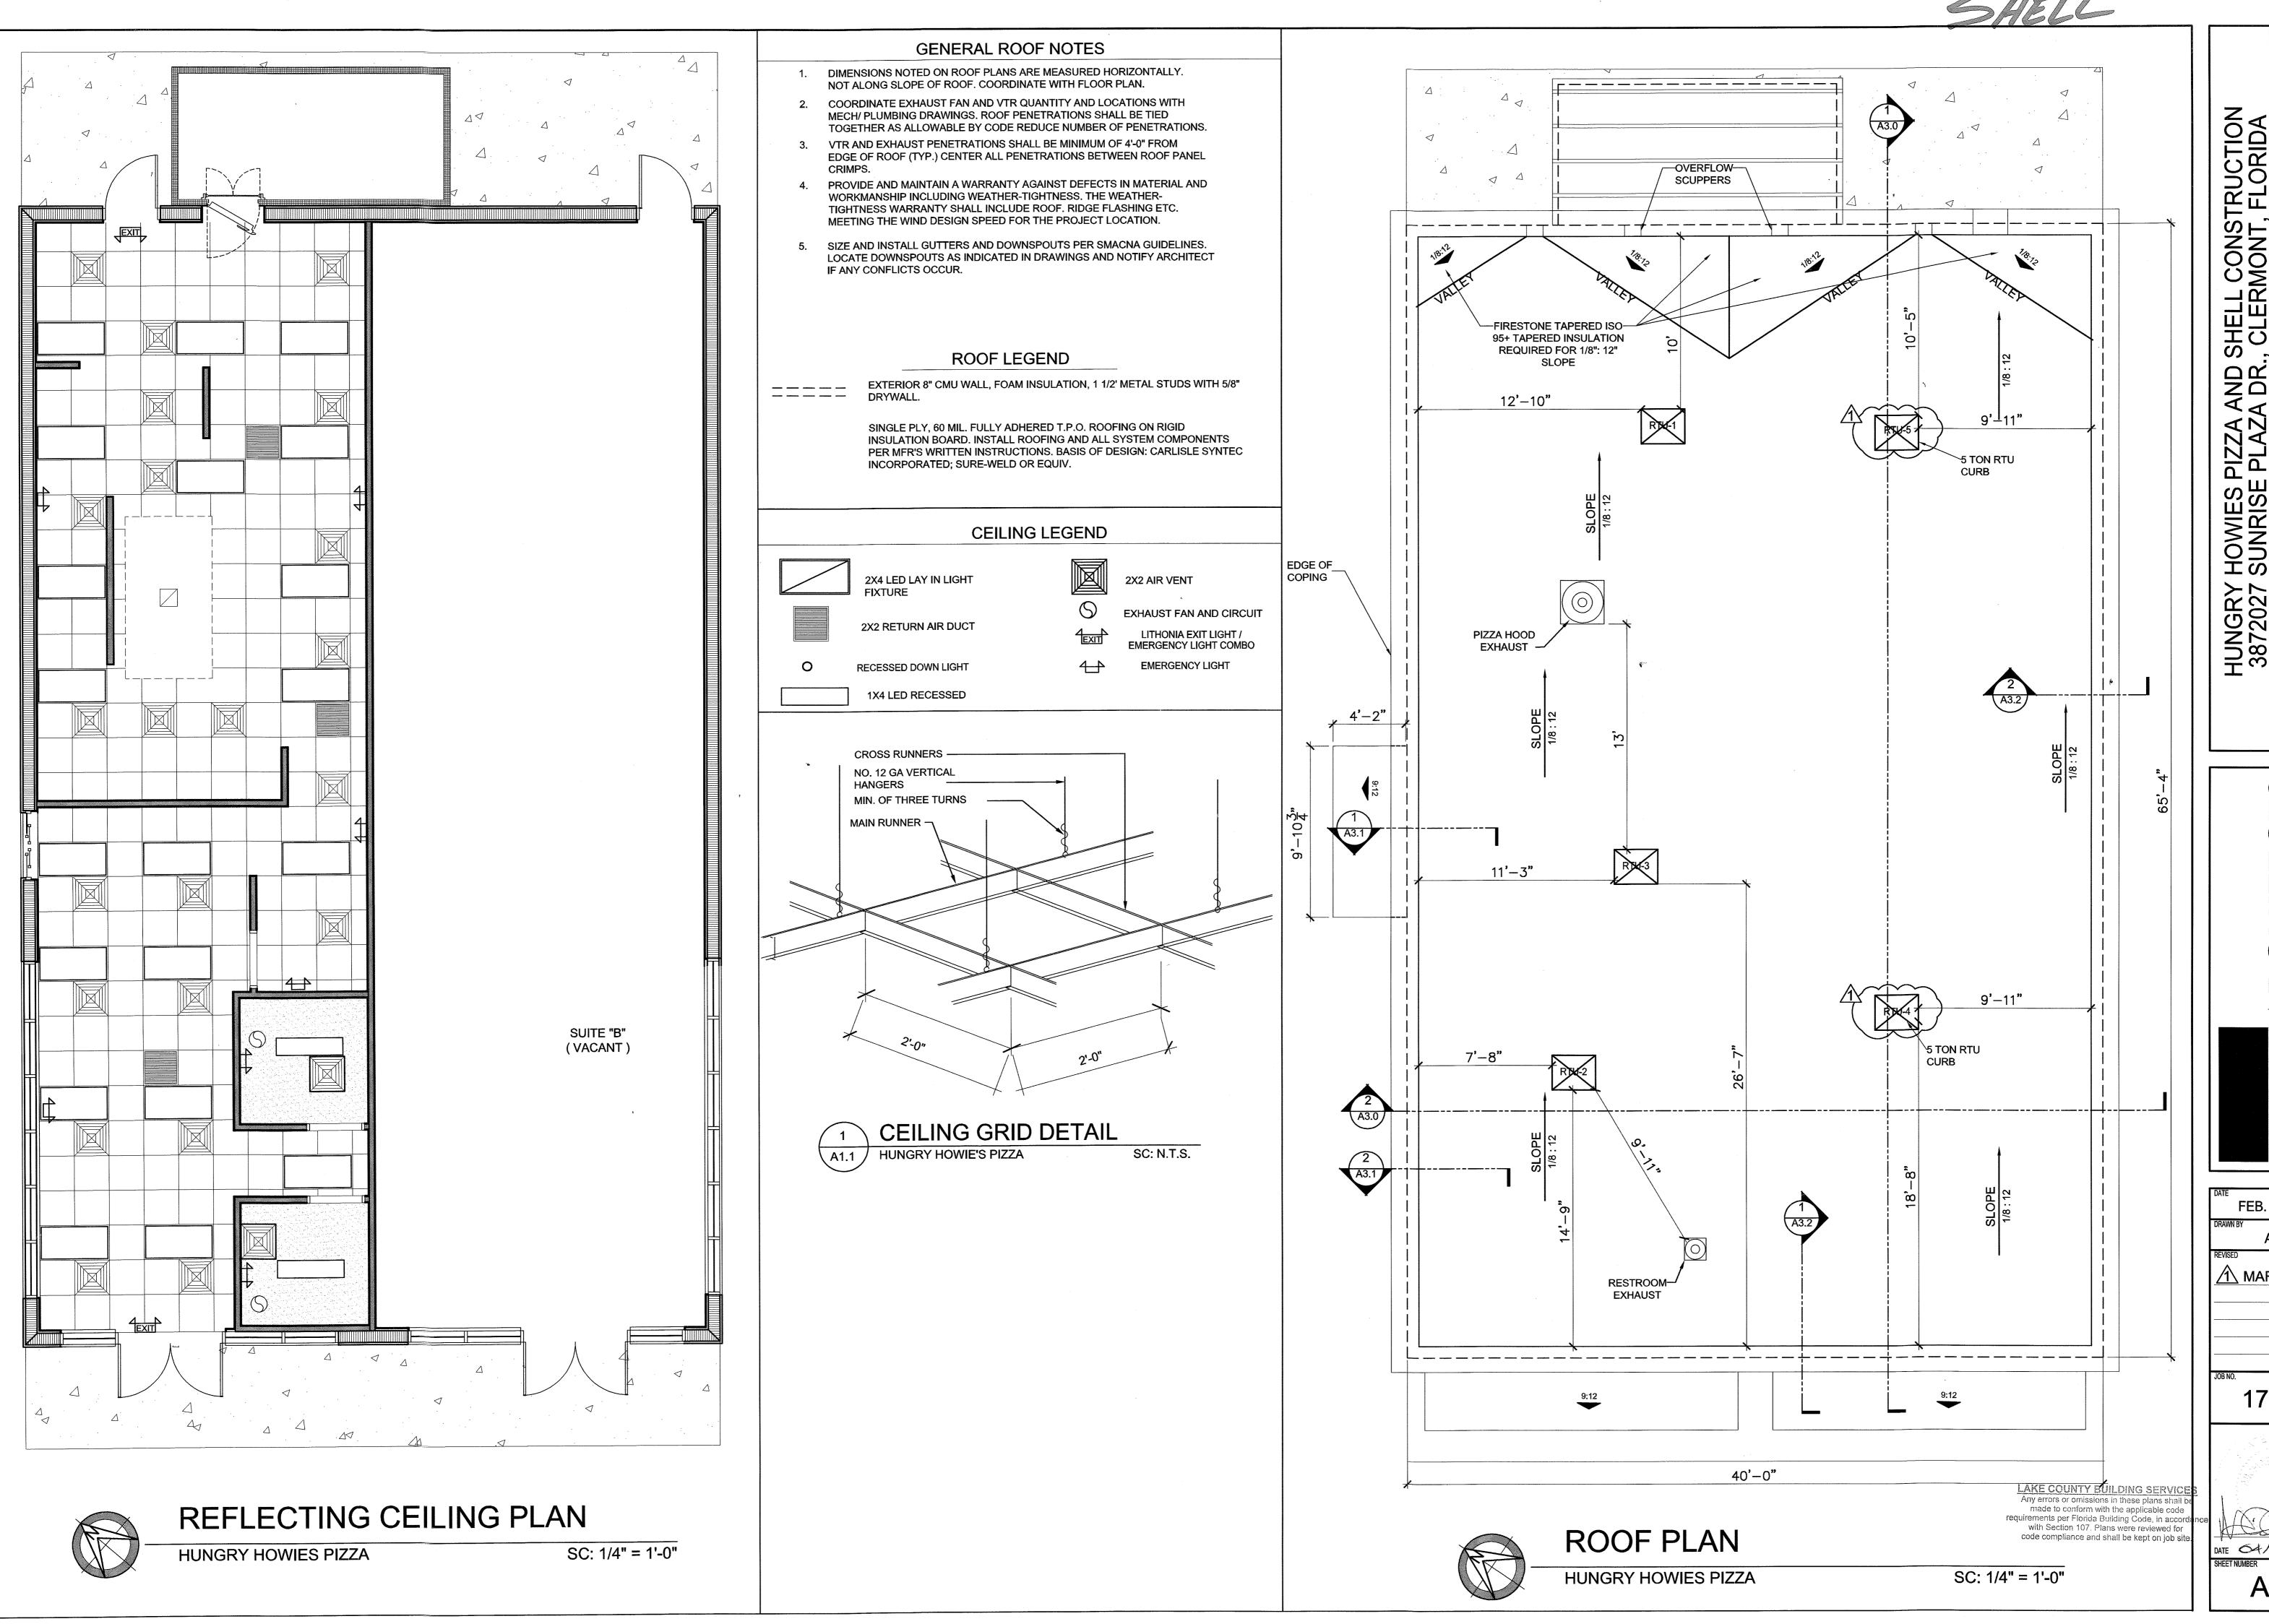

DATE 06-12-2018
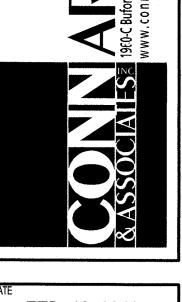
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1. INSULATE ALL EXPOSED HOT WATER PIPING AT HANDICAP LOCATIONS. 2. LAVATORIES SHALL BE MOUNTED WITH LAVATORY APRON 2'-5" A.F.F. IN

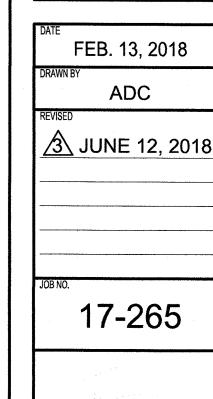CODES, THE CONTRACTOR SHOULD BRING ITEMS TO THE ATTENTION OF THE

GENERAL NOTES:

ENLARGED TOILET PLANS SHOW LOCATION OF TOILET FIXTURES, ACCESSORIES AND NOTES.

SEE FLOOR PLAN FOR INFORMATION REGARDING WALL TYPES, CONSTRUCTION

NOTES AND ROOM FINISHES. ALL STUD WALLS SURROUNDING RESTROOMS SHALL HAVE SOUND ATTENUATION

. REFER TO FINISH SCHEDULE FOR ROOM FINISHES.

TYPICAL ELEVATIONS ARE SHOWN FOR CLARITY OF FIXTURE AND ACCESSORY LOCATIONS AND HEIGHTS.

REFER TO PLANS FOR LOCATIONS

. ALL WALL MOUNTED GRAB BARS, SINKS OR OTHER EQUIPMENT SHALL HAVE BLOCKING INSTALLED AS REQUIRED.

GRAB BARS SHALL BE A MINIMUM 1 1/4" TO A MAX 1 1/2" OUTSIDE DIAMETER WITH A MINIMUM 1-1/2" CLEAR SPACE BETWEEN FINISHED FACE OF WALL AND BAR. MOUNT BARS TO SUPPORT A POINT LOAD OF 250 LBS. MIN.

PROVIDE 2X WOOD BLOCKING AT TOILET ACCESSORY LOCATIONS FOR MOUNTING

), ACCESSIBLE WATER CLOSETS, WHETHER FLOOR OR WALL MOUNTED SHALL HAVE THE SEAT. NOT RIM, AT 17" MIN. TO 19" MAX. ABOVE THE FINISHED FLOOR.

ALL OTHER PLUMBING FIXTURES, INCLUDING BUT NOT LIMITED TO - FIXTURES, HARDWARE, AND ACCESSORIES SHALL BE SELECTED BY OWNER UNLESS OTHERWISE NOTED ON DRAWINGS. CONTRACTORS ARE

RESPONSIBLE FOR COORDINATING WITH OWNER.

RESTROOM DETAILS / MOUNTING HEIGHTS

LAVATORY

& MIRROR


SOAP

DISPENSER

\ A1.2

TOILET TISSUE

DISPENSER & SIDE

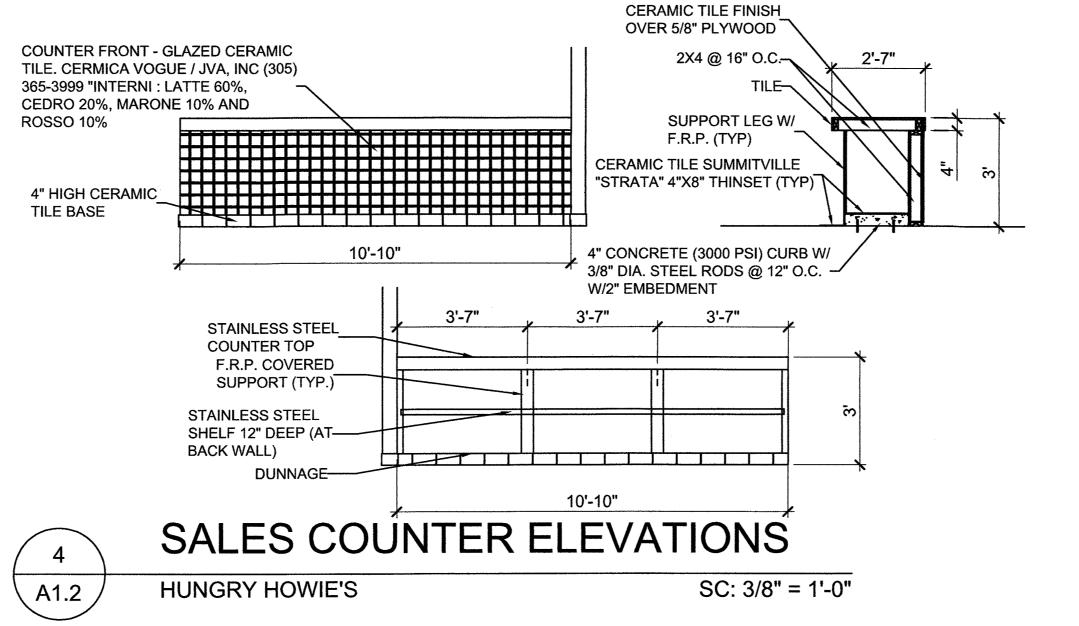

		5	1	DOOF		EVA	_	NS
		 A1.2		HUNGRY F	HOWIE	'S		
				DO	OR SC	HEDUL	.E	
· · · · · · · · · · · · · · · · · · ·		NO.	DOOR TYPE	SIZE	LABEL	FRAME TYPE	FIRE RATE	HARD
INSCOT		100	D	6'-0" X 7'-0"	N/A	ALUM.	N/A	MANUF.
	1	101	Α	3'-0" X 7'-0"	N/A	H.M.	N/A	

TYPE A SOLID CORE FLUSH WOOD

STOP

3 HINGES

SILENCERS

SILENCERS

KICKPLATE

PUSH PLATE

DEADBOLT

SILENCERS

HINGES

PULL

PASSAGE LOCKSET

2 KICKPLATE

		DO	OR SC	HEDUL	.E		
NO.	DOOR TYPE	SIZE	LABEL	FRAME TYPE	FIRE RATE	HARDWARE	NOTES
100	D	6'-0" X 7'-0"	N/A	ALUM.	N/A	MANUF. STANDARD	
101	Α	3'-0" X 7'-0"	N/A	H.M.	N/A	2	
102	Α	3'-0" X 7'-0"	N/A	H.M.	N/A	1	
103	С	3'-0" X 7'-0"	N/A	H.M.	N/A	3	
104a	D	6'-0" X 7'-0"	N/A	ALUM.	N/A	MANUF. STANDARD	
104b	В	3'-0" X 7'-0"	N/A	H.M.	N/A	3	·

US32D

GREY

US32D

US26D

US32D

GREY

US32D

US26D

US26D

GREY

SATIN NICKEL BAL

SATIN NICKEL BAL

HA

HA

HA

BES

HA

HA

DOOR TYPES

TYPE C

HOLLOW METAL

TYPE D

ALUMINUM STORE FRONT

SC: 1/4" = 1'-0"

TYPE B

HOLLOW METAL

236 W

307D

236 W

307D

2280-150

2355-150

3114

307D

190S-8" X 30"

190S-8" X 30

BB1279 4 1/2 X 4 1/2

5K-0-N-15-C-STK-626

BB1279 4 1/2 X 4 1/2

FINISH SCHEDULE								
ROOM NUMBER	ROOM NAME	FLOOR	BASE	WALL	CEILING	CEILING HEIGHT	REMARKS	
100	DINING/WAITING	CERAMIC TILE			2' X 2' ACOUST.	10'-0"	4' HIGH CERAIMIC TILE WAINSCOT	
101	ORDERING/SERVING	CERAMIC TILE	CERAMIC TILE	CERAMIC TILE	2' X 2' ACOUST.	10'-0"		
102	RESTROOM	CERAMIC TILE	CERAMIC TILE	PTD DRYWALL	DRY WALL	8'-0"	4' HIGH CERAIMIC TILE WAINSCOT	
103	KITCHEN	CERAMIC TILE	CERAMIC TILE	CERAMIC TILE	2' X 2' ACOUST.	10'-0"		
104	VACANT	NONE	NONE	NONE	NONE	OPEN		

- 2. ALL DOORWAYS SHALL HAVE A MINIMUM CLEAR OPENING OF 32" WITH THE DOOR OPEN 90 DEGREES MEASURED BETWEEN THE FACE OF THE DOOR AND THE OPPOSITE STOP.
- 3. HANDRAILS, PULLS, LOCKSETS, AND OTHER OPERATING MECHANISMS ON ENTRANCE DOORS, RESTROOM TOILET ROOM DOORS, AND OTHER MECHANISMS OR U-SHAPED HANDLES SHALL HAVE A SHAPE THAT IS EASY TO GRASP WITH ONE HAND, DOES NOT REQUIRE TIGHT GRASPING, TIGHT PINCHING, OR TWISTING OF THE WRIST TO OPERATE. THIS REQUIREMENT SHALL BE SATISFIED BY THE 5 POUND FEET STANDARD AS DESCRIBED IN THE AMERICAN NATIONAL STANDARDS INSTITUTE (1986) 4.13.
- 4. THE ELEVATION OF FLOOR SURFACES ON BOTH SIDES OF ALL DOORS SHALL NOT VARY MORE THAN 1/2". THE ELEVATION SHALL BE MAINTAINED ON BOTH SIDES OF A DOORWAY FOR A DISTANCE OF AT LEAST EQUAL TO THE WIDEST LEAF. (TYPICAL)
- 5. ALL INTERIOR FINISH ON WALLS AND CEILINGS OF EXITS AND OF ENCLOSED TRAVEL CORRIDORS FURNISHING ACCESS THERETO OR WAY OF TRAVEL THEREFROM SHALL BE "CLASS A" OR " CLASS B" IN ACCORDANCE WITH SECTION 6-5 OF THE LIFE SAFETY CODE AND TABLE 803.5 FBC-B.
- 6. FIRE EXTINGUISHERS SHALL BE PROVIDED AND INSTALLED PER NFPA 101
- 7. ALL CEILINGS IN FOOD HANDLING AREAS SHALL BE NON-POUROUS AND EASILY CLEANABLE

MANUFACTURERS USED: CODE | MANUFACTURER HAGER HINGE BES **BEST ACCESS SYSTEMS** CR CORBIN RUSWIN BAL BALDWIN VD **VON DUPRIN** DORMA HES HES ASSA ABLOY

TYPE B ALUMINUM STORE FRONT 19'-4" MASONRY OPENING TYPE A
ALUMINUM STORE FRONT

 ∞

4'-

A1.2

GLAZING ELEVATIONS **HUNGRY HOWIE'S** A1.2

TOILET 2

ENLARGED TOILET PLAN

SPANDREL SPANDREL GLASS

N.T.S.

4'-0" MASONRY OPENING

SC: N.T.S

-SPANDREL GLASS SO YOU

CANNOT SEE BATHROOM

HUNGRY HOWIES PIZZA

19'-4" MASONRY OPENING

16'-0" MASONRY OPENING

16'-0" MASONRY OPENING

8. ALL BASE IN FOOD HANDLING AREAS SHALL BE CARED BASE.

TYPE D .3'-1" ,,,3'-1" , DRIVE-THRU WINDOW HARDWARE SCHEDULE **GENERAL NOTES:** MFG. REMARKS 1. ALL DOORS SHALL BE OPERABLE BY A SINGLE EFFORT. THE DOORS AND CLOSERS MARK QTY MODEL NUMBER SHALL BE ADJUSTED SUCH THAT EXTERIOR SWINGING DOORS CAN BE OPERATED BY HINGES BB1279 4 1/2 X 4 1/2 US26D NOT MORE THAN 8.5 POUNDS OF FORCE ON THE LATCH STILE, INTERIOR DOORS BY PRIVACY LOCKSET US26D BES 5K 0R 15-STL 626 NOT MORE THAT 5.0 POUNDS OF FORCE. (SEE ALSO 553.48 (4).(1).7F.S. CLOSER DC3200-A1-626-(RH/LH)-M54 US26D CR

HUNGRY HOWIES PIZZA AND SHELL CONSTRUC 3872027 SUNRISE PLAZA DR., CLERMONT, FLO

SSOCAILS 1960-C Buford Blvd. Tallahassee, Florida 32308 Thone/Fax: 850-878-8784 www.connandassociates.com License No. AA C001662

FEB. 13, 2018

DRAWN BY
ADC

REVISED

MAR. 26, 2018

JUNE 12, 2018


JOB NO.

17-265

DATE

O6-12-2018

SHEET NUMBER

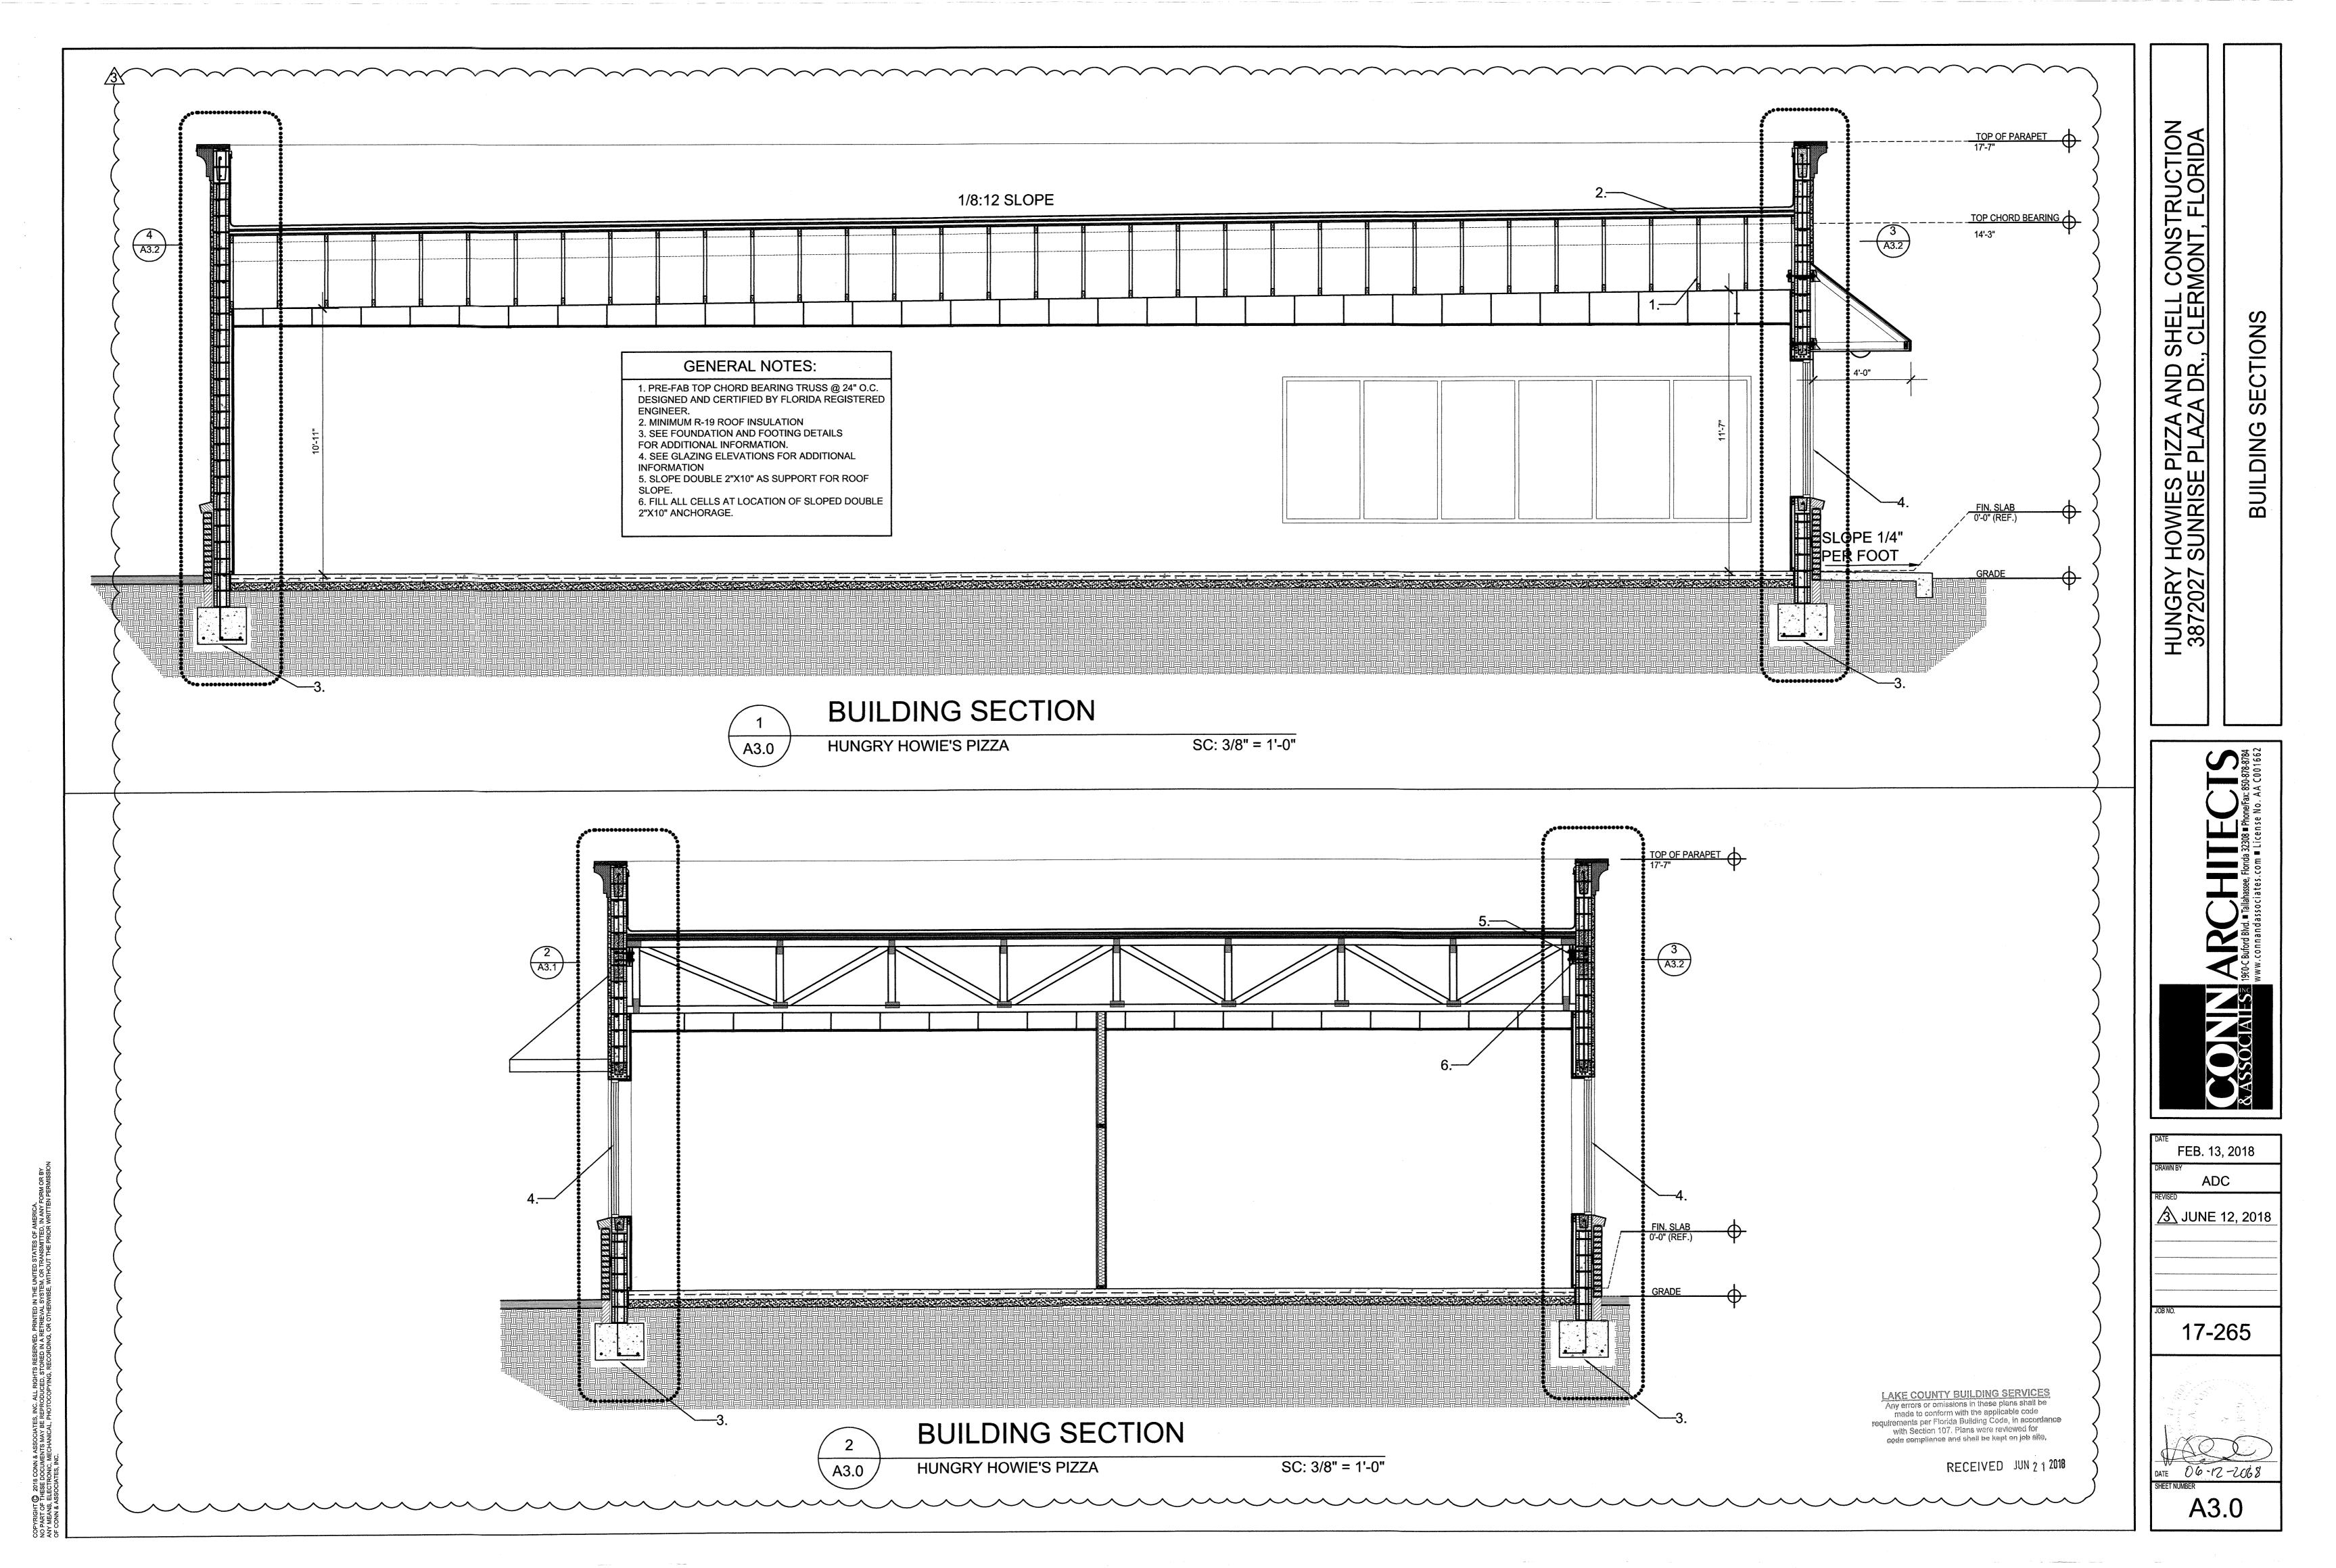

HUNGRY HOWIES PIZZA AND SHELL CONSTRUCTION 3872027 SUNRISE PLAZA DR., CLERMONT, FLORIDA

SECTIONS

FEB. 13, 2018

DRAWN BY
ADC

REVISED

MAR. 26, 2018

JUNE 12, 2018

JOB NO.

17-265

DATE 06-12-20/8
SHEET NUMBER

A3.1

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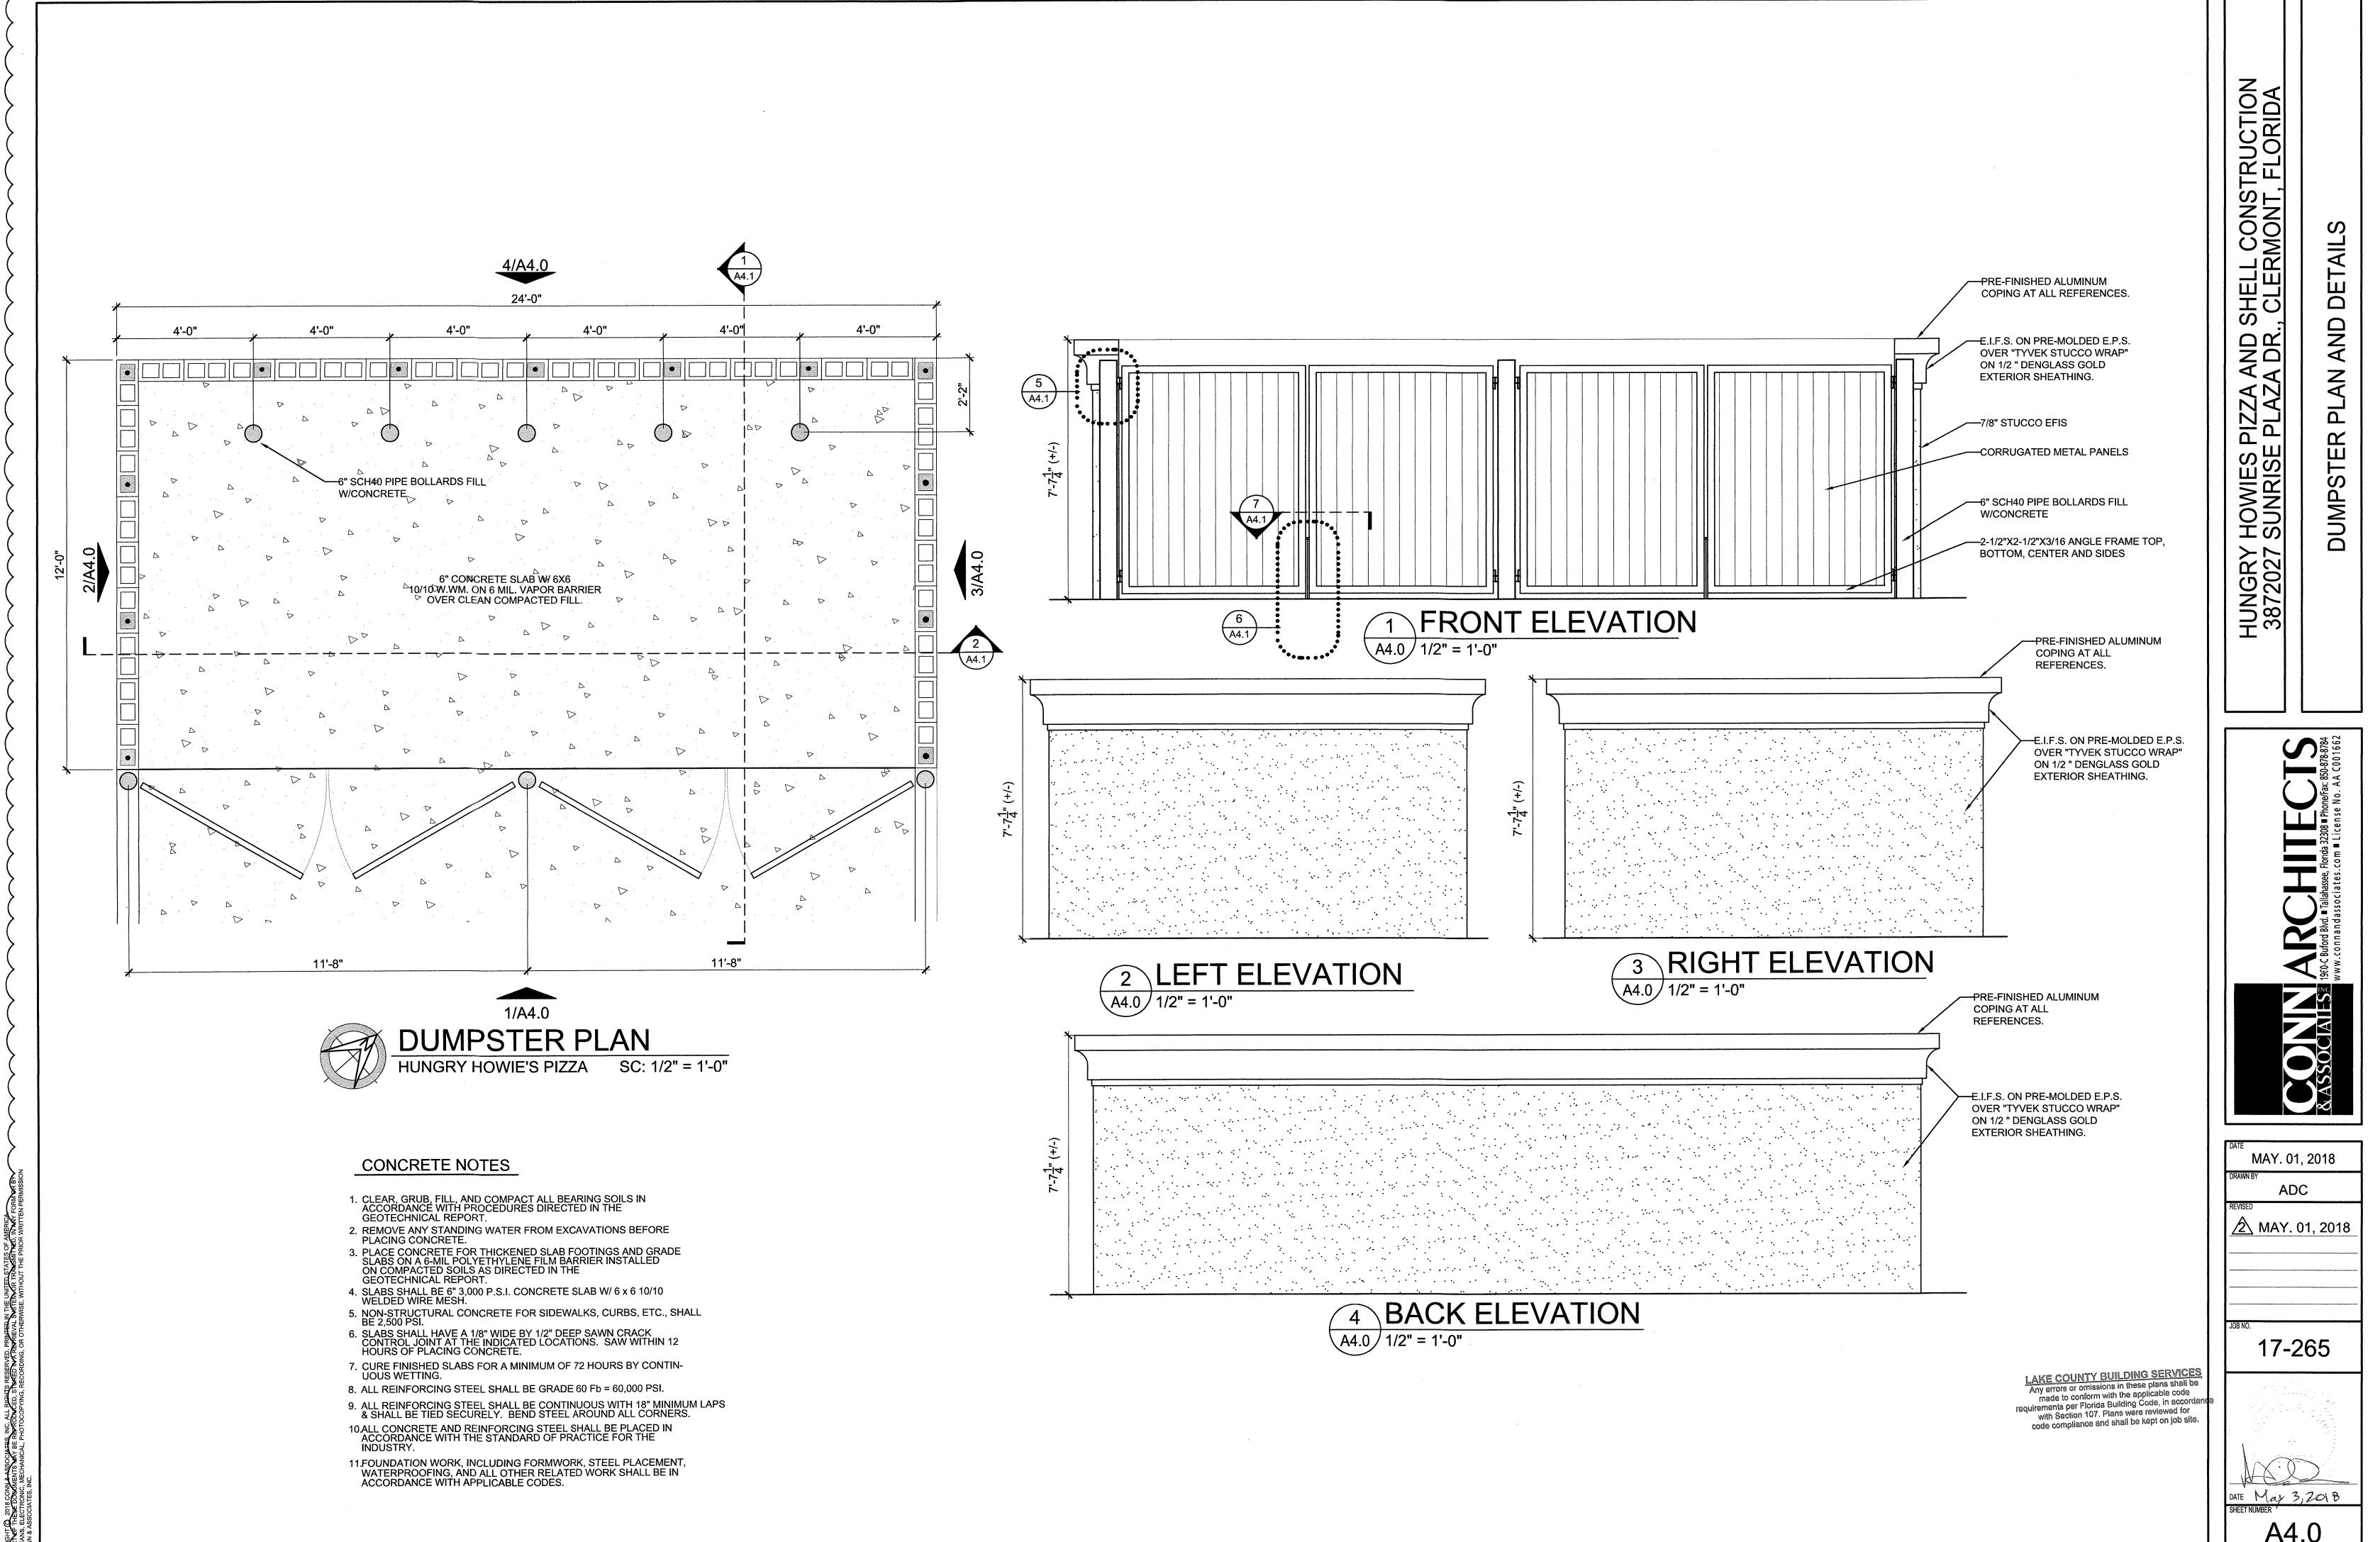
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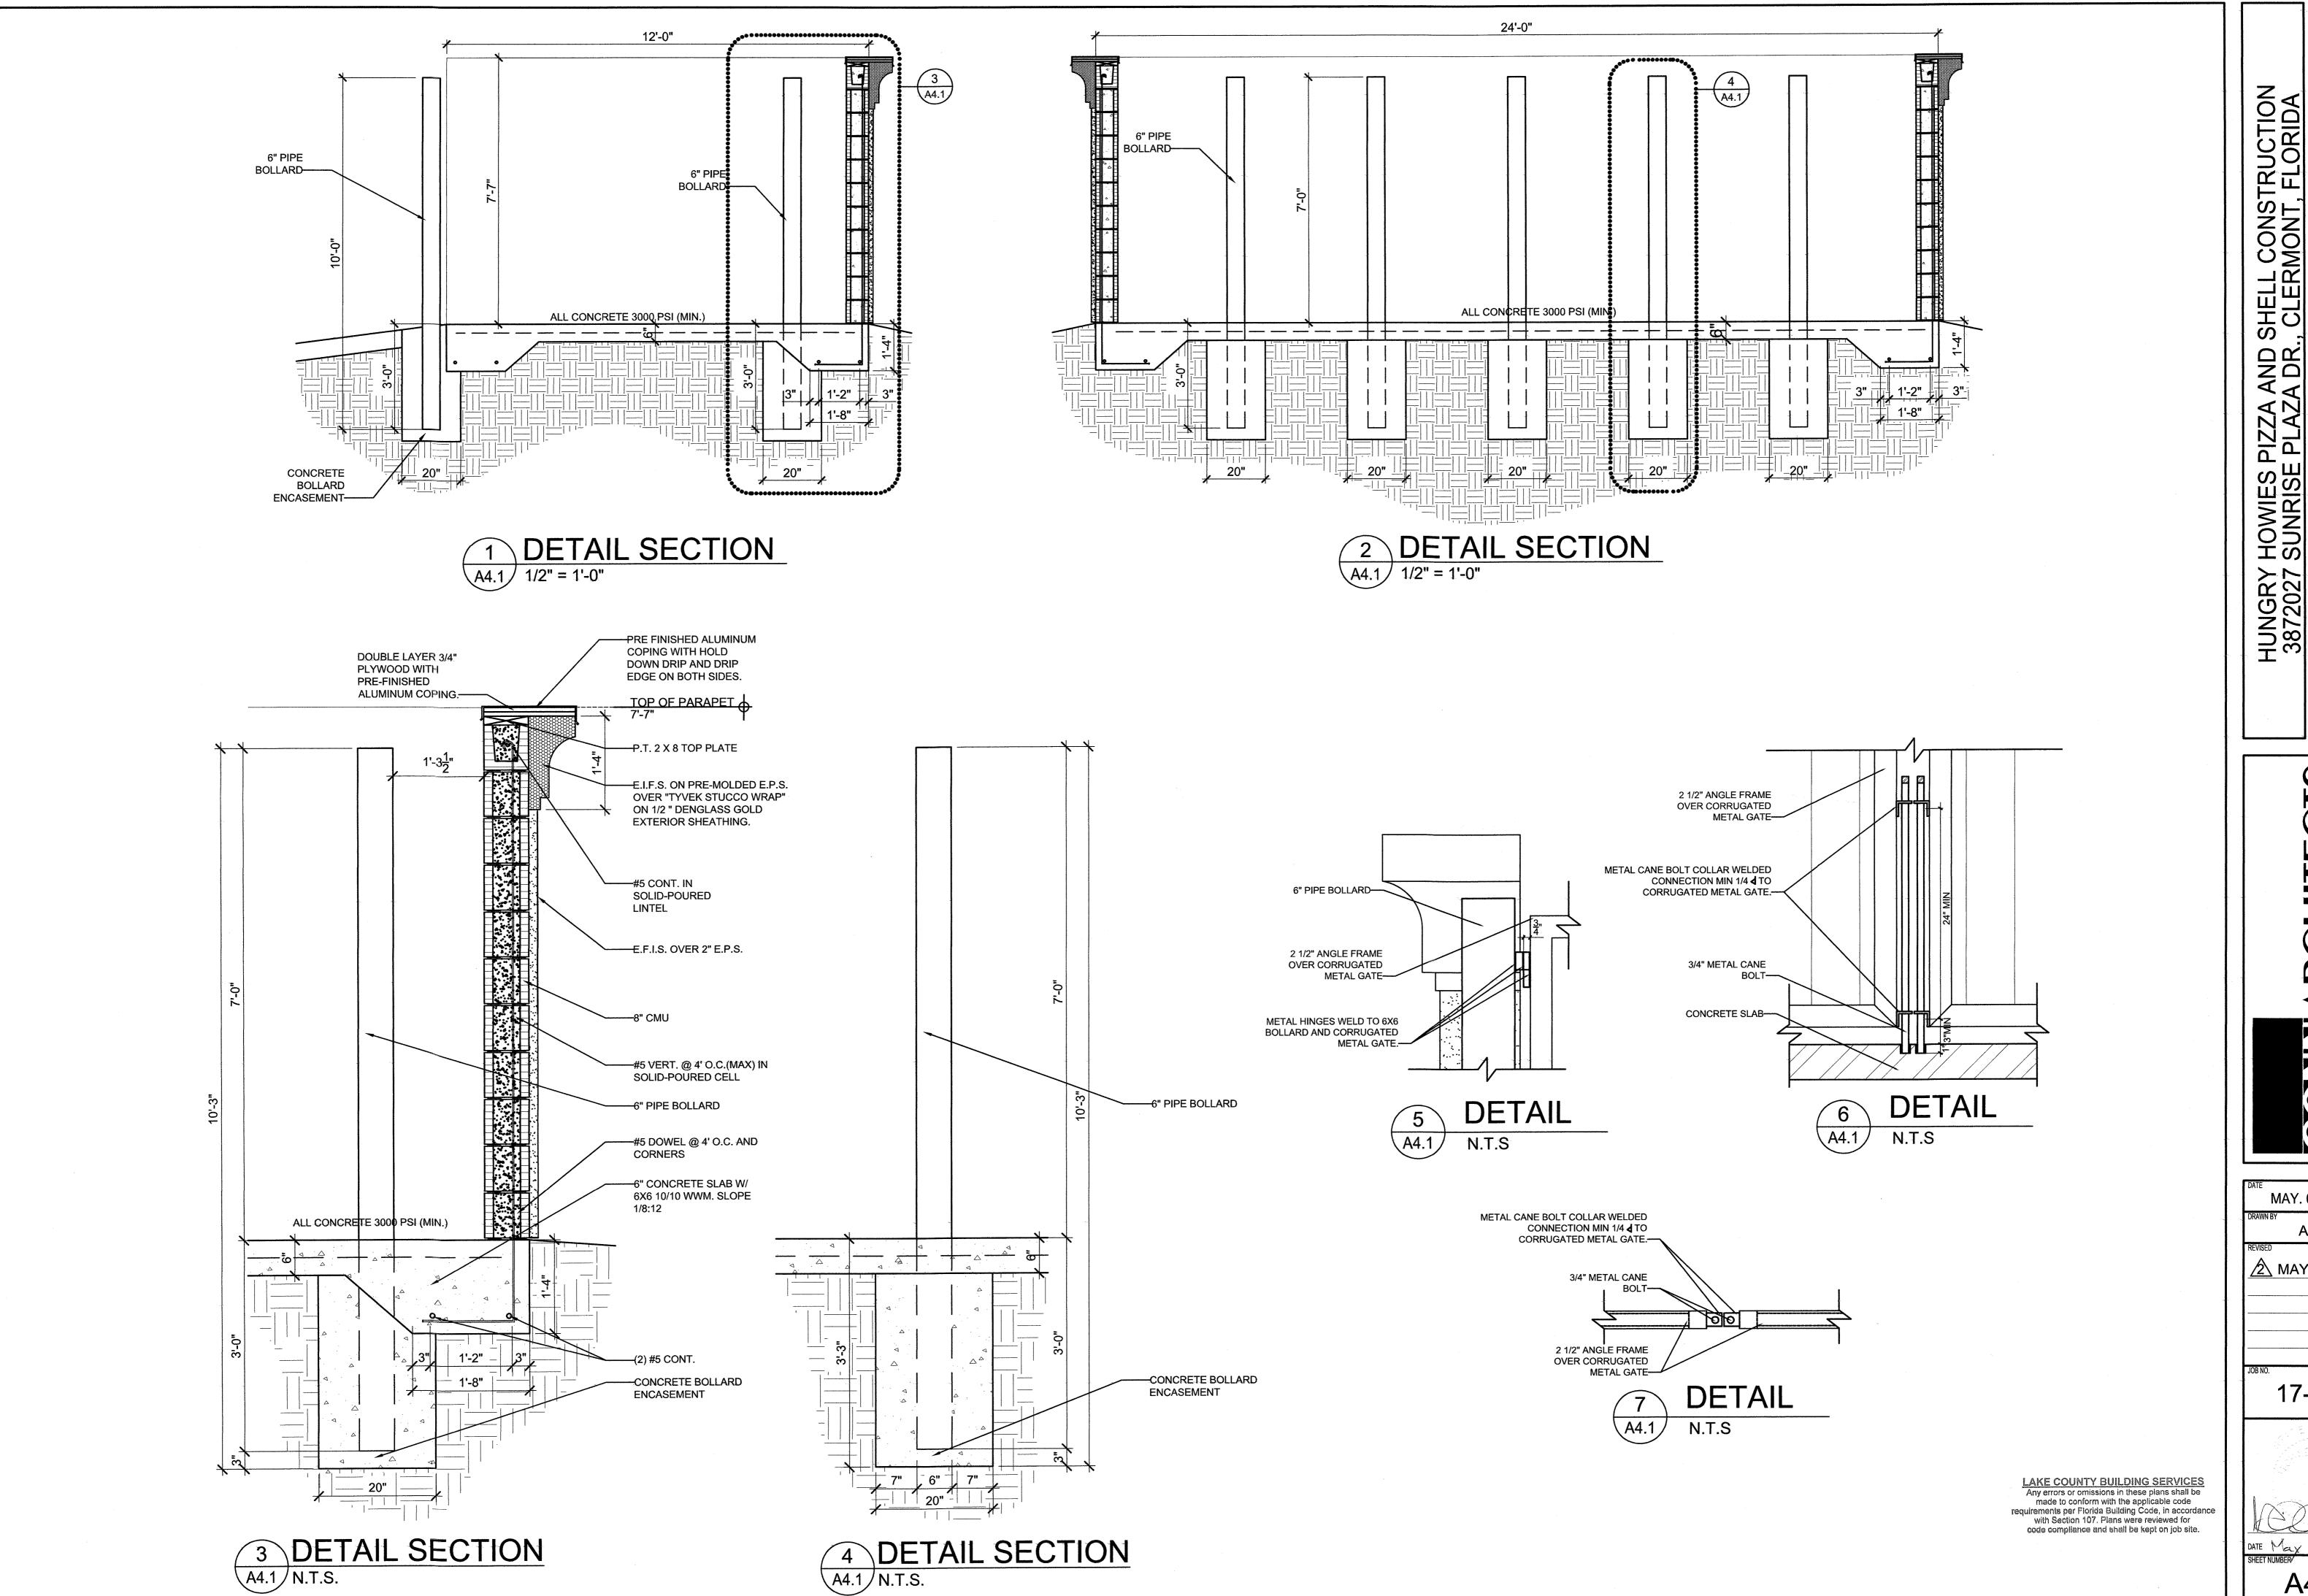
3 JUNE 12, 2018

17-265

DATE 06-12-2018
SHEET NUMBER

A3.2





SHELL CONSTRUCTION, CLERMONT, FLORIDA AND A DR.

MAY. 01, 2018 ADC

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17-265

DATE Max 3, 2018 A4.1

2. INSTALL ALL WORK IN ACCORDANCE WITH THE FLORIDA PLUMBING CODE, FLORIDA FIRE PREVENTION CODE, LOCAL PLUMBING CODES. WHERE CONFLICTS OCCUR BETWEEN DOCUMENTS AND CODES, THE MOST RESTRICTIVE REQUIREMENTS SHALL GOVERN.

3. ALL WORK SHALL BE INSTALLED IN A WORKMANLIKE MANNER BY EXPERIENCED TRADESMEN

CONTRACTOR SHALL FIELD VERIFY ALL GIVEN MEASUREMENTS PRIOR TO LAYING AND CONNECTING ALL SANITARY AND WASTE PIPING AND NOTIFY ARCHITECT OF ANY DISCREPANCIES.

CONTRACTOR SHALL BE RESPONSIBLE FOR PROVIDING ALL NECESSARY SUPPORTING DEVICES FOR ALL FIXTURES INCLUDED IN CONTRACT OR HEREIN SPECIFIED OR OTHERWISE.

6. CONTRACTOR SHALL GIVE 24 HOURS NOTICE TO APPLICABLE UTILITY COMPANY PRIOR TO PERFORMING WORK INVOLVING UTILITIES.

7. PLUMBERS SHALL BE LICENSED BY STATE AND LOCAL AUTHORITIES TO INSTALL ALL PIPING.

8. GENERAL CONTRACTOR IS TO VERIFY ALL IN-SLAB - ROUGH-INS LOCATIONS BEFORE POURING SLABS.

9. LOCATIONS OF ANY WASTE & SUPPLY LINES SHOWN ARE ONLY APPROXIMATE. PLUMBING CONTRACTOR SHALL VERIFY THESE LOCATIONS

10. CONTRACTOR SHALL BE RESPONSIBLE FOR PROVIDING ALL NECESSARY FITTINGS AS REQUIRED BY ALL APPLICABLE CODES AND GOVERNING AUTHORITIES.

11. CONTRACTOR SHALL VERIFY AND CORRECT AS REQUIRED TO MEET ALL CODES AND REGULATIONS ANY POSSIBLE DISCREPANCIES BETWEEN TYPE AND SIZE OF CONNECTION SPECIFIED IN PLUMBING FIXTURE SCHEDULE AND FIXTURES ACTUALLY INSTALLED ON THE SITE

12. CONTRACTOR SHALL COORDINATE ALL WORK WITH OTHER TRADES

BEFORE PROCEEDING WITH WORK.

13. CONTRACTOR SHALL BE RESPONSIBLE FOR MAINTAINING FIRE RATING AND WEATHERPROOFING INTEGRITY OF ALL PIPING AND PENETRATIONS.

14. UTILITY CONNECTIONS INDICATED ON THE PLANS ARE BEST INFORMATION AVAILABLE TO THE DESIGNERS AND SHALL BE FIELD VERIFIED BY THE CONTRACTOR.

15. ALL POTABLE WATER PIPING SHALL BE DISINFECTED IN ACCORDANCE WITH SECTION 1207 OF THE STANDARD PLUMBING CODE AND VERIFIED BY WRITTEN REPORT FROM THE FLORIDA STATE BOARD OF HEALTH.

16. ALL PLUMBING LINES SHALL BE CONCEALED IN FLOORS, WALLS, OR ABOVE CEILINGS AS APPLICABLE EXCEPT AT IMMEDIATE FIXTURE.

17. PVC PIPING SHALL NOT BE USED IN UNENCLOSED LOCATIONS WITHIN THE BUILDING. COPPER IS ACCEPTABLE

18. ALL SANITARY PIPING SHALL HAVE A 1/8" PER FOOT SLOPE UNLESS OTHERWISE NOTED

19. VALVES AND FITTINGS SHALL BE OF SAME SIZE AS LINE ON WHICH THEY ARE LOCATED, UNLESS OTHERWISE INDICATED ON DRAWINGS.

20. ALL WATER SUPPLY AND SANITARY LINES SHALL BE RUN AS CLOSE TO PLANS AS POSSIBLE WITH NO CHANGES IN SIZING.

21. ALL WATER SUPPLY AND SANITARY LINES SHALL BE RUN AS CLOSE TO PLANS AS POSSIBLE WITH NO CHANGES IN SIZING.

22. ROUTE ALL PIPING CONCEALED ABOVE CEILINGS, WITHIN WALLS, OR IN CHASES EXCEPT AS SPECIFICALLY NOTED.

23. CONTRACTOR SHALL INSTALL DIELECTRIC UNIONS AT CONNECTIONS OF DISSIMILAR METALS

24. ALL WATER PIPING INSTALLED IN EXTERIOR WALLS SHALL BE PLACED ON THE INTERIOR SIDE OF THE WALL, SO THAT WALL INSULATION CAN BE PLACED ON THE EXTERIOR SIDE OF THE PIPING.

25. PROVIDE CUT-OFF VALUES AT LAVATORIES, SINKS, WATER CLOSET, AND REFRIGERATOR ICE MAKER SUPPLY BOXES.

26. PROVIDE SHUT-OFF VALUE FOR MAIN SERVICE ENTER INTO BUILDING

27. WATER HEATER SHALL BE PLACED IN A METAL PAN WITH 4" SIDES AND 2" TRAPPED WASTE. 3/4" PRESSURE RELIEF LINES FROM WATER HEATER SHALL LEAD DIRECTLY TO EXTERIOR.

28. VENT PIPING SHOWN ON FLOOR PLANS IS ONLY INDICATIVE EXCEPT FOR VTR LOCATIONS.

29. ALL VENTS THROUGH ROOF SHALL BE MIN. 10'-0' FROM ANY AIR INTAKES.

30. ALL HOSE BIBS AND FAUCET WITH HOSE THREAD CONNECTION TO HAVE VACUUM BREAKER.

31. PLUMBING CONTRACTOR SHALL VERIFY IF PRESSURE REDUCING VALUE IS NEEDED

32. ALL NEW HOT WATER PIPING THAT WILL CONVEY WATER IN EXCESS OF 105 DEGREES SHALL BE INSULATED AS PER ENERGY CODE SECTION 13-411.AB.2 AND RELATED TABLE.

33. GREASE RECEPTOR TO BE 750 GALLONS UNLESS APPROVED BY THE POLK COUNTY HEALTH DEPARTMENT.

34. A WASTE WATER-SUPPLIED TRAP PRIMER DEVICE SHALL SUPPLY WATER TO THE TRAP, WASTE WATER-SUPPLIED TRAP PRIMER DEVICES

34. A WASTE W	FORM TO AS	SSE 1044. THE DISCH	ARGE PIPE FROM TH	HE SEAL PRIMER DEVICE SHALL CONNECT TO THE TRAP ABOV	E THE SEAL
ON THE INL	ET SIDE OF	THE TRAP			
31				FIXTURE SCHEDULE	
			RUN-OUT SIZES		

			PLU	MBING	FIXTURE SCHEDULE			
0)/14001	ENTURE TYPE	RUN	-OUT SI	ZES	DESCRIPTION			
SYMBOL	FIXTURE TYPE	WASTE	CW	HW	DESCRIPTION			
P-1	WATER CLOSET (ADA COMPLIANT)	3"	3/4"		FLUSH VALUE TYPE TOILET (ADA), SELECTED BY OWNER			
P-2	LAVATORY (ADA COMPLIANT) MOUNT IN ACCORDANCE W/ ARCH. PLANS	1-1/4"	1/2"	1/2"	LAVATORY: CRANE "1412V", VITREOUS CHINA, WALL-MOUNTED LAVATORY, KEENEY 17 GAUGE CAST BRASS P-TRAP WITH CLEANOUT, 1/2" X 3/8" ANGLE STOPS & SUPPLIES (CHROME) INSULATED DRAIN AND SUPPLY FITTINGS WITH PVC JACKET, ADA COMPLIANT WITH CONCEALED WALL CARRIER. FAUCET TO BE SELECTED BY OWNER (PROVIDE ALLOWANCE)			
P-3	THREE COMPARTMENT SINK	1-1/2"	1/2"	1/2"	SINK AND FAUCET TO BE SELECTED BY OWNER (PROVIDE ALLOWANCE)			
P-4	WATER HEATER		3/4"	3/4"	A.O. SMITH "199,000 BTU, HOT WATER HEATER, OR EQUAL.			
P-5	MOP SINK		3/4"	3/4"	FLOOR MOP SINK			
P-6	HAND SINK		3/4"	3/4"	EMPLOYEE HAND SINKS			
P-7	FLOOR DRAIN	4"	-	-				
P-8	ICE MACHINE		3/4"	-	SELECTED BY OWNER			
P-9	FLOOR SINK	3"		-	SELECTED BY OWNER			

PLUMBING FIXTURE NOTES:

1. ALL FAUCETS, DRAINS, TRIM, AND FIXTURE ACCESSORIES SHALL HAVE AN OIL-RUBBED BRONZE FINISH UNLESS OTHERWISE INDICATED.

2. ALL FIXTURES SHALL BE COMPLETE WITH FAUCETS, DRAINS, P-TRAPS, STOP VALVES, AND SUPPLY LINES.

3. ALL FIXTURES SHALL BE WHITE UNLESS OTHERWISE INDICATED. 4. ALL TOILETS SHALL BE 12" ROUGH-IN.

5. CONTRACTOR SHALL PROVIDE ALL PIPING, VALVES, FITTINGS, ETC. AS NECESSARY FOR COMPLETE AND OPERATIONAL USE OF ALL FIXTURES.

6. ALL PLUMBING PIPES SHALL BE INSULATED WITH 3/4" ARMAFLEX PIPE INSULATION.

7. ALL ADA LAVATORY TRIM SHALL BE INSULATED WITH 1/2" ARMAFLEX PIPE INSULATION AND WRAPPED WITH PRE-FORMED PVC JACKET KITS.

PLUMBING FIXTURE ALLOWANCE NOTE:


THE ABOVE SPECIFICATIONS ARE GIVEN AS EITHER AN ALLOWANCE COST AMOUNT OR BASIS OF DESIGN SPECIFICATION. THE CONTRACTOR SHALL INCORPORATE THESE SPECIFICATIONS AND

ALLOWANCES INTO THE BASE BID. THE COST ALLOWANCES GIVEN ARE FOR COST OF FIXTURE/MATERIAL ONLY AND DO NOT INCLUDE LABOR / INSTALLATION COSTS. THE

CONTRACTOR SHALL INCORPORATE ALL NECESSARY LABOR / INSTALLATION COSTS INTO THE

BASE BID. UNLESS NOTED OTHERWISE, EACH COST ALLOWANCE GIVEN IS ON A PER-FIXTURE BASIS. THE CONTRACTOR SHALL BE RESPONSIBLE FOR TAKING OFF FIXTURE COUNTS FROM THE DRAWINGS


AND DETERMINING THE OVERALL COST ALLOWANCE FOR EACH CATEGORY. THE OMISSION OF AN ITEM OR COMPONENT FROM THE FOLLOWING LIST DOES NOT RELIEVE THE CONTRACTOR OF INCLUDING SUCH ITEMS IN THE BASE BID. ANY QUESTIONS OR CLARIFICATIONS SHOULD BE ADDRESSED TO THE ARCHITECT IN WRITING PRIOR TO THE DEADLINE FOR BIDDING QUESTIONS.

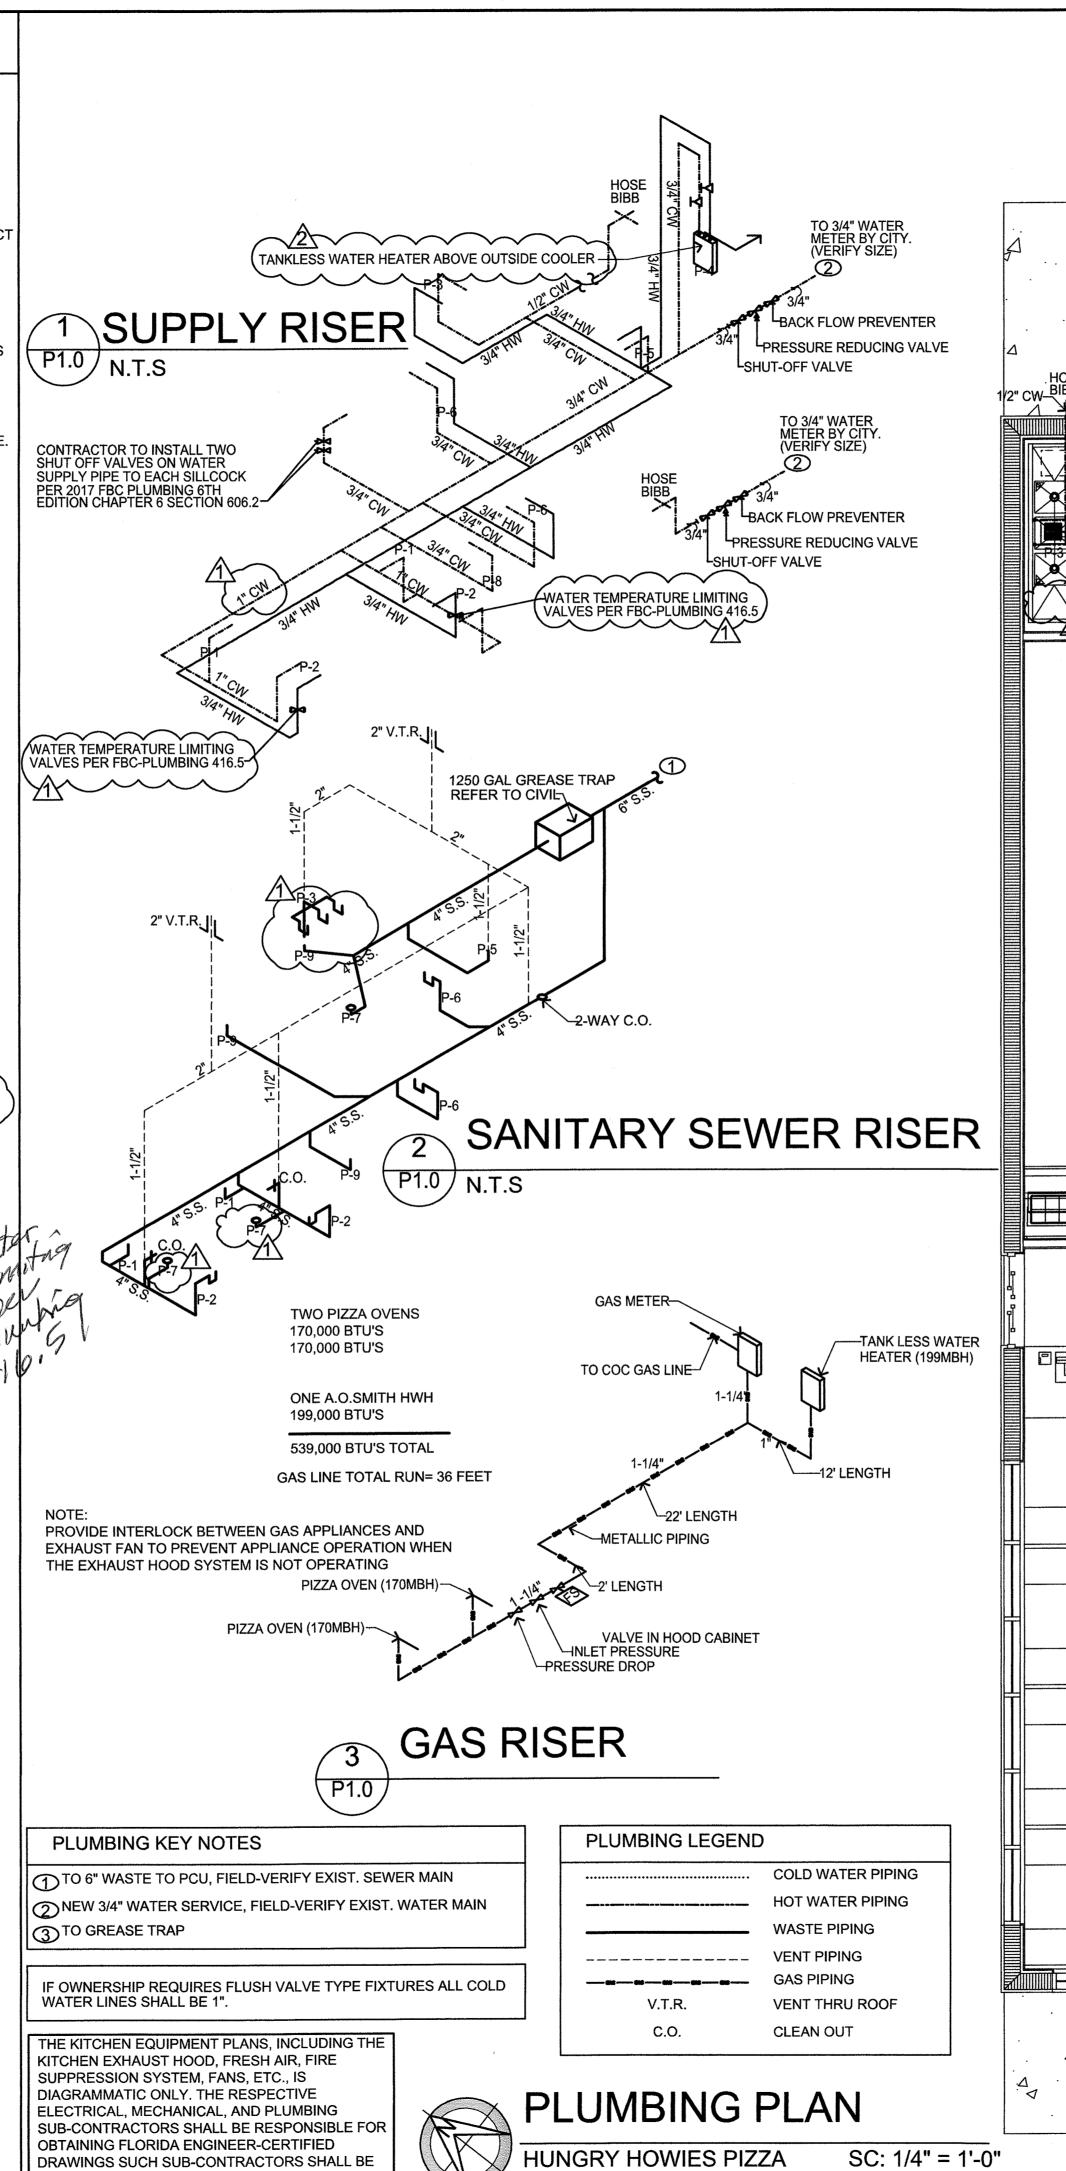

DRAWINGS SUCH SUB-CONTRACTORS SHALL BE

RESPONSIBLE FOR PROFESSIONAL INSTALLATION.

SC: 1/4" = 1'-0"

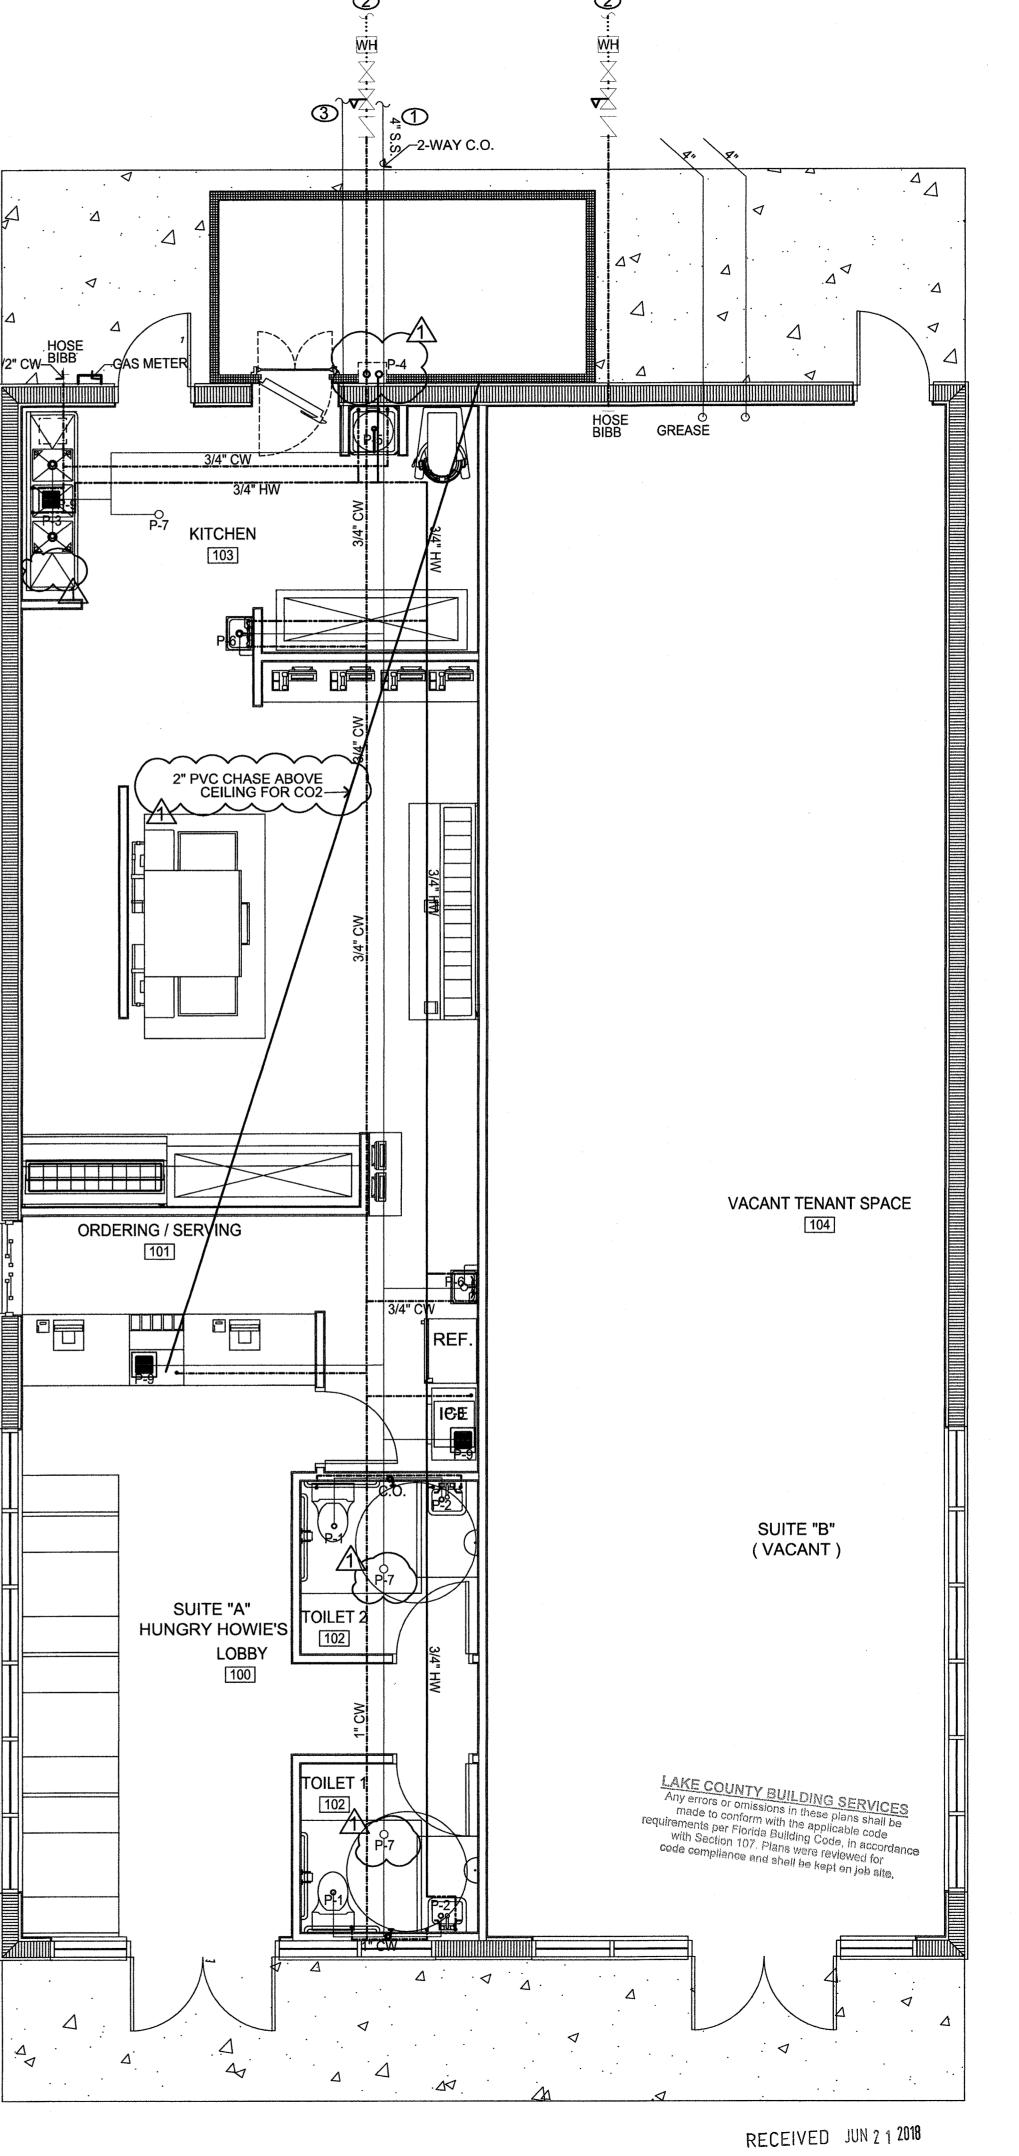

TRUCTION, FLORIDA HELL CONST S ZO HUNGR 387202

FEB. 13, 2018 /1\ MAR. 26, 2018 3 JUNE 12, 2018 17-265 DATE 00-12-2018

BEFORE FABRICATION, VERIFY AND COORDINATE ALL DIMENSIONS IN FIELD.

VERIFY WITH ELECTRICAL CONTRACTOR BEFORE ORDERING.

4. ALL DUCTS SHALL BE GROUNDED ACROSS FLEXIBLE CONNECTIONS.

5. PROVIDE ACCESS PANELS FOR ACCESS TO DEFLECTING DEVICES IN DUCT.

DUCT SIZES AND OPENINGS THRU ROOF SLABS AND WALL PARTITIONS SHALL SUIT EQUIPMENT FURNISHED.

COORDINATE DIFFUSER AND REGISTER LOCATIONS WITH ELECTRICAL LIGHTING LAYOUT AND ARCHITECTURAL REFLECTED CEILING PLANS.

8. DUCTWORK LOCATIONS AND CLEARANCES SHALL BE COORDINATED WITH PLUMBING PLANS.

LOCATE THERMOSTAT 4'-0" ABOVE FINISHED FLOOR UNLESS OTHERWISE INDICATED.

10. ALL EQUIPMENT, DUCTWORK, ETC. SHALL BE SUPPORTED AS DETAILED. PROVIDE ADDITIONAL SUPPORTS AS REQUIRED TO PROVIDE A VIBRATION-FREE RIGID INSTALLATION.

11. INSIDES OF DUCT VISIBLE THROUGH GRILLES, REGISTERS OR DIFFUSERS SHALL BE PAINTED FLAT BLACK.

12. ALL WORK SHALL BE COORDINATED WITH ALL TRADES INVOLVED. OFFSETS IN DUCT AND PIPING (INCLUDING DIVIDED DUCT) AND TRANSITIONS AROUND OBSTRUCTIONS SHALL BE PROVIDED AT NO ADDITIONAL COST TO THE OWNER.

13. REFER TO TYPICAL DETAILS FOR PIPING AND INSTALLATION OF EQUIPMENT

14. CONDENSATE DRAINS FROM AIR HANDLING UNITS SHALL BE COORDINATED WITH PLUMBING PLANS FOR PROPER DRAINAGE TO SUIT EQUIPMENT FURNISHED. ROUTE TO STORM DRAIN OR TO FRENCH DRAIN MEASURING MIN. 24" DIAM. BY 24" DEPTH. CONDENSATE LINE TO EXTEND MIN. 6" DEEP INTO FRENCH DRAIN A SECONDARY DRAIN OR AUXILIARY DRAIN PAN SHALL BE REQUIRED FOR EACH COOLING OR EVAPORATOR COIL OR FUEL-FIRED APPLIANCE THAT PRODUCES CONDENSATE, WHERE DAMAGE TO ANY BUILDING COMPONENTS WILL OCCUR AS A RESULT OF OVERFLOW FROM THE EQUIPMENT DRAIN PAN OR STOPPAGE IN THE CONDENSATE DRAIN PIPING.

15. ACCESS PANELS IN DUCTWORK AND CEILINGS SHALL BE PROVIDED WHERE REQUIRED FOR OPERATION AND MAINTENANCE OF ALL FANS, DAMPERS, AND MECHANICAL EQUIPMENT.

16. PROVIDE SMOKE DETECTORS IN SUPPLY SIDE OF THE SYSTEM PRIOR TO ANY BRANCH CONNECTIONS AS PER NFPA 90A.

. PROVIDE CEILING MOUNTED AUDIO / VISUAL ALARMS , IN OCCUPIED SPACE , CONNECTED BRANCH CONNECTIONS AS PER NFPA 90A.

18. ALL MECHANICAL HVAC SHALL BE INSTALLED PER NFPA 90A

19. INSTALL BACKDRAFT DAMPERS, VOLUME DAMPERS, INSECT SCREENS, AND APPROVED WEATHER PROOF WALL LOUVERS ON ALL OUTSIDE AIR

20. ALL CONDENSATE DRAINS SHALL COMPLY WITH FBC-M 307.2.3.

21. ALL OPERATION AND MAINTENANCE MANUALS SHALL BE PROVIDED TO THE BUILDING OWNER AND SHALL BE AVAILABLE TO BUILDING OFFICIALS UPON REQUEST.

22. A DUCT LEAKAGE TEST, ADJUST AND BALANCE SHALL BE COMPLETED PER FBC-EC 503.2.9.1 WHEN TOTAL CONDITIONED SPACE EXCEEDS 5000 S.F. IF REQUIRED THE CONTRACTOR SHALL PROVIDE THE BUILDING DEPARTMENT OR INSPECTOR A LETTER OF ACCEPTANCE FROM THE OWNER/ENGINEER PRIOR TO OBTAINING THE FINAL INSPECTION

23. EACH THERMOSTAT, AIR HANDLER AND CONDENSER SHALL BE PERMANENTLY IDENTIFIED SUCH THAT THE AREA SERVED IS READILY IDENTIFIED AND IN COMPLIANCE WITH FBC-M 304.12

FRESH AIR CALCULATIONS

FBCM TABLE 403.3 FOOD AND BEVERAGE SERVICE / FAST FOOD

Rp= 7.5 CFM / PERSON Ra = 0.18 CFM / S.F.

TOTAL FRESH AIR

1,225 S.F. x 0.18 CFM / S.F. = 221 CFM 32 PEOPLE x 7.5 CFM PER A PERSON = 240 CFM

TOTAL FRESH AIR REQUIRED = 221 + 240 = 461 CFM/3= 154 PER UNIT (7" F.A. INTAKE PER UNIT)

100 CFM PER FIXTURE 2 FIXTURES TOTAL

200 CFM TOTAL RESTROOM EXHAUST

HVAC UNIT LIST

UNIT 1 (5 TON) RTU PROVIDE 5KW HEAT STRIP AND

THERMO. W/ HUMIDITY CONTROL

UNIT 2 (5 TON) RTU PROVIDE 5KW HEAT STRIP AND THERMO. W/ HUMIDITY CONTROL

UNIT 3 (5 TON) RTU PROVIDE 5KW HEAT STRIP AND THERMO. W/ HUMIDITY CONTROL

AIR HANDLER AND HEAT PUMP UNITS AS SPECIFIED ABOVE, OR EQUIVALENT SPECIFICATION FROM ALTERNATE MANUFACTURER (WITH THE SAME POWER REQUIREMENTS) ALL UNITS SHALL BE 13 SEER MINIMUM

DUCT SIZES SHOWN REPRESENT REQUIRED SIZE NEEDED FOR AIR FLOW. ALTERNATE SIZED DUCTS THAT ALLOW THE SAME AIR FLOW WILL BE ALLOWED. MECHANICAL CONTRACTOR TO VERIFY ALL DUCT SIZES PRIOR TO COMMENCEMENT OF WORK AND SHALL NOTIFY ARCHITECT IMMEDIATELY OF ANY DISCREPANCIES.

MECHANICAL KEY NOTES


22" X 30" ACCESS HATCH AT LOWERED CEILING / MECHANICAL PLATFORM

 \bigcirc FAF-1: FRESH AIR INTAKE, FAN WIRE TO 0_2 SENSORS.

OIRECT RETURN AIR GRILL BELOW HVAC UNIT, 18" X 18" DIRECT UNIT DUCT, DAMPER TO BALANCE AIR FLOW.


(4) KITCHEN EXHAUST HOOD, FRESH AIR, FIRE SUPPRESSION SYSTEM, FANS, ETC., IS DIAGRAMMATIC ONLY. THE RESPECTIVE ELECTRICAL, MECHANICAL, AND PLUMBING SUB-CONTRACTORS SHALL BE RESPONSIBLE FOR OBTAINING FLORIDA ENGINEER-CERTIFIED DRAWINGS. SUCH SUB-CONTRACTORS SHALL BE

RESPONSIBLE FOR PROFESSIONAL INSTALLATION.

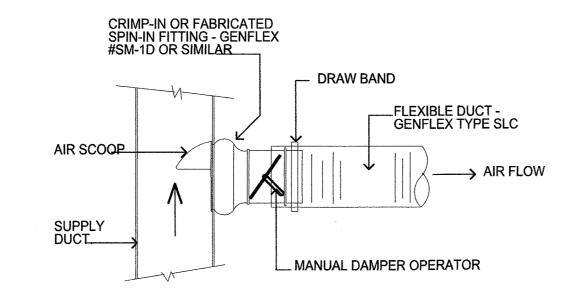


NOTE: MAXIMUM LENGTH OF FLEXIBLE DUCT IS 14'-0"

TYP. FLEX DUCT CONNECTION

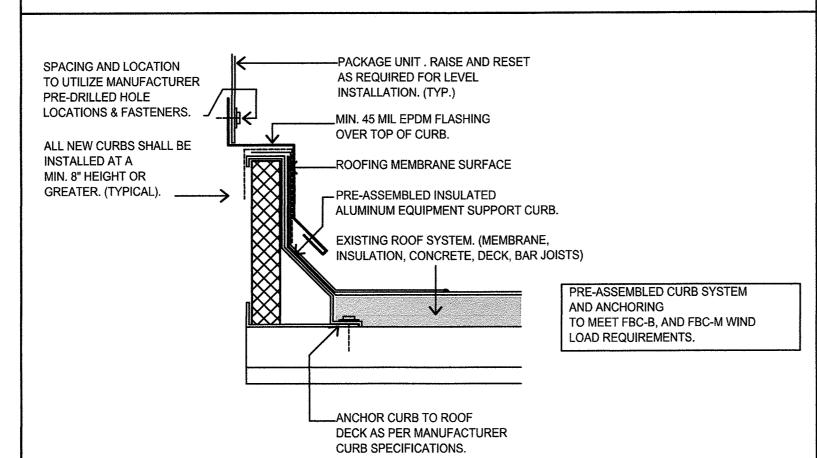

MOUNTING DETAIL

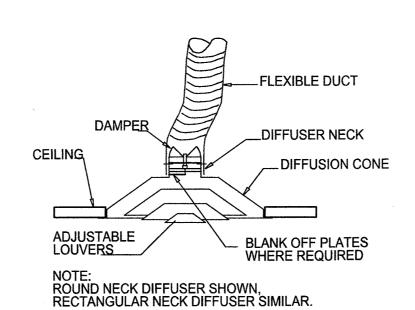


DIFFUSER MOUNTING DETAIL M1.0 N.T.S

MECHANICAL SYMBOLS LEGEND

SUPPLY AIR DUCT

RETURN AIR DUCT

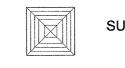


SUPPLY AIR REGISTER (CEILING MOUNTED)

EXHAUST FAN (CEILING MOUNTED)

FLEXIBLE DUCT (8" TYP.)

FRESH AIR INTAKE

FLEX DUCT SIZING GUIDE							
DUCT SIZE							
6" DIAM.							
8" DIAM.							
10" DIAM.							
14'-0" MAX. FLEX DUCT LENGTH							

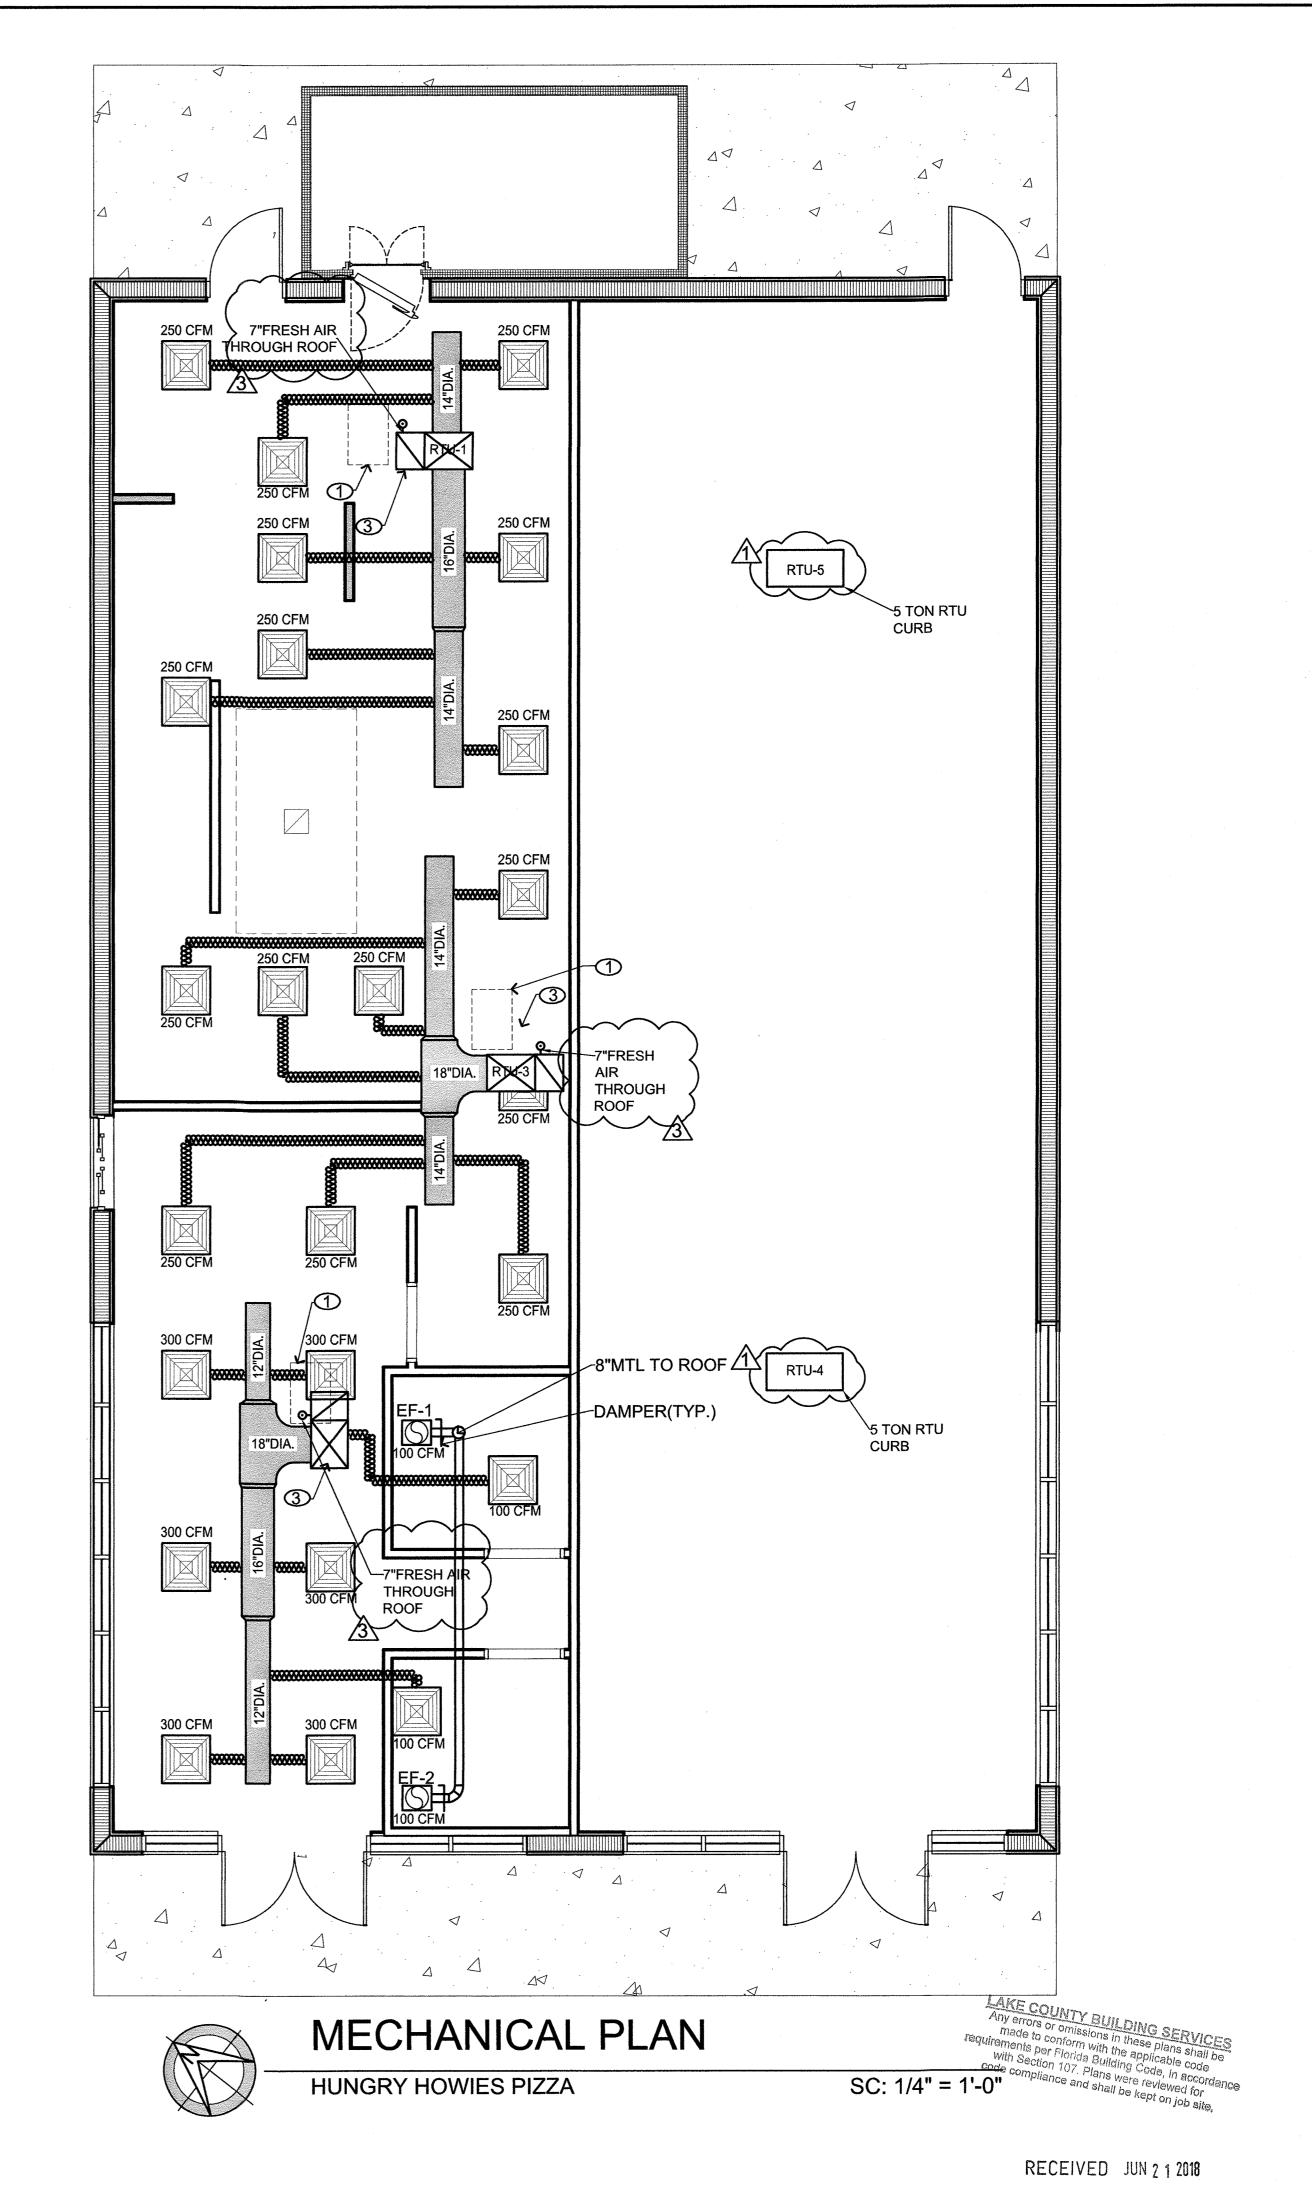

SHELL CONST CLERMONT, S AND A DR.

HUNGRY 3872027

MECHANICAL

FEB. 13, 2018 ADC /1\ MAR. 26, 2018 <u>∕3\</u> JUNE 12, 2018 17-265 06-12-2018

GENERAL ELECTRICAL NOTES

- 1. ALL WIRING SHALL BE IN ACCORDANCE WITH THE 2017 EDITION OF THE FLORIDA BUILDING CODE 2014 EDITION OF THE NATIONAL ELECTRICAL CODE, THE 2017 EDITION OF THE FLORIDA FIRE PREVENTION CODE, THE LATEST EDITION OF NFPA 72, NATIONAL FIRE ALARM CODE, AND THE FOLLOWING DESIGN CRITERIA:
 - THE CONTRACTOR IS RESPONSIBLE FOR ACQUIRING PERMITS FOR THIS CONSTRUCTION AND SCHEDULING APPROPRIATE INSPECTIONS DURING CONSTRUCTION WITH ALL AUTHORITIES HAVING JURISDICTION. CONTRACTOR SHALL FURNISH OWNER WITH AN INSPECTION CERTIFICATE FROM ALL INSPECTORS HAVING JURISDICTION.
- THE CONTRACTOR SHALL CONTACT THE CITY OF WINTER HAVEN ELECTRICAL UTILITY DEPARTMENT PRIOR TO COMMENCING WORK, IN ORDER TO DETERMINE COSTS ASSOCIATED WITH THE ELECTRICAL SERVICE. ALL SUCH COSTS ARE TO BE COVERED BY CONTRACTOR.
- 4. THE CONTRACTOR SHALL BE LICENSED BY THE STATE OF FLORIDA ACCORDING TO FS 489.
- CONTRACTOR SHALL COORDINATE WITH THE APPROPRIATE UTILITY FOR METERING AND SERVICE CONNECTION REQUIREMENTS PRIOR TO COMMENCING WORK.
- ALL MATERIAL AND EQUIPMENT SHALL BEAR A LABEL OF APPROVAL FROM A NATIONALLY RECOGNIZED ELECTRICAL TESTING LABORATORY.
- ALL WIRE TO BE COPPER, THWN, THHN OR XHHW. MINIMUM WIRE SIZE IS #12 THHN CU.UNLESS OTHERWISE NOTED.
- NO CONDUIT IS TO BE INSTALLED ON EXTERIOR OF THE BUILDING.
- ENT OF "SMURF" TUBING, AND M/C CABLE ARE APPROVED WHEN USED AS PER NEC. PERFERED CONDUIT SHALL BE EMT, IMC OR PVC FOR UNDERGROUND AND UNDERSLAB INSTALLATIONS.
- 10. CONDUIT SHALL BE INSTALLED PARALLEL OR PERPENDICULAR TO BUILDING LINES.
- ELECTRICAL EQUIPMENT AND CONDUIT SHALL BE CONCEALED OR RECESSED AND INSTALLED IN A NEAT AND WORKMANLIKE MANNER.
- 12. ANY CONDUIT PENETRATING THE ROOF OR WALLS SHALL HAVE WATER-TIGHT FLASHING, AND PAINT TO RESTORE PENETRATION TO ORIGINAL CONDITION AND APPEARANCE. ALL EXTERIOR ELECTRICAL EQUIPMENT SHALL BE WEATHERPROOF.
- 13. ELECTRICAL CONTRACTOR SHALL COORDINATE WITH MECHANICAL CONTRACTOR TO AVOID CONFLICTS BETWEEN LOCATIONS OF DIFFUSERS AND LIGHTING FIXTURES. COORDINATE WITH OTHER TRADES TO PROVIDE ALL NEEDED ELECTRICAL SERVICE.
- 14. THE MECHANICAL CONTRACTOR SHALL PROVIDE ALL LOW VOLTAGE CONTROL WIRING FOR ALL HVAC SYSTEMS, ELECTRICAL CONTRACTOR SHALL PROVIDE POWER SOURCE FOR ALL CONTROL SYSTEMS.
- CONTRACTOR SHALL VERIFY ALL DOOR SWINGS WITH ARCHITECTURAL DRAWINGS BEFORE ROUGH IN SWITCHES AND SHALL VERIFY EXACT LOCATION OF ALL MOTORS AND EQUIPMENT BEFORE ROUGH-in,
- THE ELECTRICAL CONTRACTOR SHALL VERIFY THE EXACT LOCATION OF COUNTER TOPS, BACKSPLASHES AND EQUIPMENT LOCATION ON ARCHITECTURAL DETAILS AND/OR EQUIPMENT AND CASEWORK SHOP DRAWINGS AND SHALL ADJUST SPECIFIED MOUNTING HEIGHTS OF WALL OUTLETS, RECEPTACLES AT COUNTERS, AND J-BOXES AS REQUIRED TO BEST SERVE EQUIPMENT. VERIFY WIRING REQUIREMENTS TO ALL EQUIPMENT.
- 17. CONTRACTOR SHALL CHECK ALL LIGHTING FIXTURES FOR EXACT TYPE MOUNTING AND SPACE REQUIRED BEFORE ROUGHING IN. SUPPORT OF ALL LIGHTING FIXTURES SHALL BE THE RESPONSIBILITY OF THIS CONTRACTOR.
- 18. ALL NEW FLUORESCENT FIXTURES SHALL BE EQUIPPED WITH ENERGY CONSERVING LAMPS AND ELECTRONIC BALLASTS. THD SHALL NOT EXCEED 10 PERCENT.
- 19. EACH PANEL IS TO BE FURNISHED WITH A TYPED DIRECTORY WITH SPECIFIC ROOM NAMES.
- 20. ALL CIRCUIT BREAKERS SERVING HVAC EQUIPMENT SHALL BE HACR RATED. PROVIDE PROPER CLEARANCE SPACE TO COMPLY WITH NEC 110-26.
- 21. KITCHEN RECEPTACLE CIRCUITS IN KITCHENS SHALL HAVE ONLY 2 RECEPTACLES PER 20 AMP CIRCUIT LIGHTING CIRCUITS ARE TO HAVE A MAXIMUM 1500 WATTS CONNECTED LOAD. RECEPTACLE CIRCUITS, OTHER THAN THE KITCHEN RECEPTACLES, ARE TO HAVE A MAXIMUM OF 7 RECEPTACLES PER
- 22. ANY DAMAGE TO THE BUILDING OR EQUIPMENT BY ELECTRICAL WORKERS SHALL BE REPAIRED BY WORKERS SKILLED IN THIS TYPE OF WORK AT NO EXPENSE TO THE OWNER.
- 23. EACH PANELBOARD AND DISCONNECTING MEANS SHALL BE MARKED TO INDICATE ITS PURPOSE AND
- 24. INSTALL PANELBOARD AND DISCONNECTS SO TO PROVIDE A 30" WIDE BY 3-1/2" DEEP CLEAR WORKING

OF SUFFICIENT DURABILITY TO WITHSTAND THE ENVIRONMENT INVOLVED PER NEC 110.22.

- SPACE IN FRONT OF THE EQUIPMENT.
- 25. PROVIDE A DISCONNECTING MEANS FOR EACH WATER HEATER PER FPC 504.4

CIRCUIT.

- 3. ALL BRANCH CIRCUIT HOMERUNS OVER 100 FEET SHALL BE #10 THHN CU.
- 27. ALL BOXES TO BE A 4" SQUARE METAL BOX WITH APPROPRIATE RING AND BONDING JUMPER.
- 28. THE MAXIMUM GAP AROUND ANY RECESSED BOX SHALL NOT EXCEED 1/8" AND THE MAXIMUM SETBACK SHALL NOT EXCEED 1/4".
- 29. ALL WIRING DEVICES SHALL BE TERMINATED AT THE SCREW ACCORDING TO WIRE WRAP REQUIREMENTS OF THE NEC.THE PUSH IN TERMINATIONS SHALL NOT BE USED.
- 30. SWITCH BOXES SHALL BE INSTALLED 48" TOP OF BOX AND RECEPTACLE BOXES INSTALLED AT 16"
- BOTTOM OF BOX.
- 31. EMT CONDUIT SHALL BE SUPPORTED EVERY 10 FEET AND WITHIN 3' OF EACH TERMINATION POINT PER NEC 358.30.
- 32. STAGGER BACK TO BACK WALL BOXES IN ALL WALLS BY AT LEAST ONE STUD.
- 3. PVC CONDUIT SHALL BE AT LEAST 12" UNDER SIDEWALKS AND 24" UNDER PARKING LOTS AND
- 34. UNDERGROUND SERVICE CONDUCTORS SHALL BE MARKED WITH A WARNING RIBBON AT LEAST 12" ABOVE THE CONDUIT PER NEC 300.5(3).
- 35. ALL ELECTRICAL EQUIPMENT IN VICINITY OF GAS CYLINDERS SHALL BE AT 60" AFF PER NFPA 99
- 36. VOLTAGE DROP SHALL NOT EXCEED 2% AND 5% TOTAL.
- COORDINATE TELEPHONE AND CABLE SERVICE INSTALLATION. INSTALL 2" PVC CONDUIT WITH PULL STRING FOR EACH SERVICE.
- 38. PROVIDE OPERATING AND INSTALLATION INSTRUCTIONS TO THE OWNER FOR ALL INSTALLED EQUIPMENT.
- 9. FS BOXES ARE NOT APPROVED AS A SUPPORT FOR A GRADE MOUNTED LIGHT FIXTURE.
- 40. INSTALL A NEUTRAL TO ALL SWITCH BOXES.
- 41. ALL RECEPTACLES INSTALL OUTSIDE SHALL BE SUNLIGHT RATED.
- 42. CONFIRM MAXIMUM AVAILABLE FAULT CURRENT IS MARKED ON SERVICE EQUIPMENT.
- 43. SEAL ALL INCOMING RACEWAYS IN ACCORDANCE WITH 300.5(G).
- 44. INSTALL BONDING BUSHINGS AND JUMPERS WHERE REDUCING WASHERS ON CONCENTRIC OR ECCENTRIC KNOCKOUTS ARE USED.


	SYMBOL LEGEND						
SYMBOL	DESCRIPTION						
-ф- ю	WALL-MOUNTED OR RECESSED INCANDESCENT, FLUORESCENT, OR HID FIXTURE. REFER TO LIGHTING FIXTURE SCHEDULE FOR TYPE AND MOUNTING.						
\$	FLUSH-MOUNTED SINGLE POLE SWITCH. MOUNT AT 48" A.F.F., WITHIN 4" OF DOOR FRAME, LOCK-SET SIDE. SUBSCRIPT 3 INDICATES THREE-WAY SWITCH.						
∯ ∯ w	FLUSH-MOUNTED CONVENIENCE RECEPTACLE WITH GROUND, NEMA 5-20. MOUNT AT 18" A.F.F. OR AS NOTED. (WP=WEATHERPROOF, GFI=CONNECTED TO GND. FAULT INTERRUPT CKT.)						
₩	DUPLEX RECEPTACLE, 44" A.F.F. OR 6" ABOVE COUNTER. TURN HORIZONTAL.						
#	DOUBLE DUPLEX RECEPTACLE						
	DISCONNECT SWITCH. SIZED AND NUMBER OF POLES AS SHOWN OR TO CONNECTED LOAD IN ACCORDANCE WITH NEC. SWITCH TO BE SQUARE D QUICK-MAKE, QUICK-BREAK TYPE, NEMA 3R FOR EXTERIOR.						
(5)	EXHAUST FAN. VENT TO OUTSIDE THRU METAL DUCT. SWITCH WITH LIGHTS IN SAME ROOM, OR AS SHOWN ON PLANS. COORD. W/ MECHANICAL PLAN.						
1⊗	ILLUMINATED EXIT SIGN. ARROWS INDICATE DIRECTION TO EXIT. REFER TO LIGHTING FIXTURE SCHEDULE FOR TYPE AND MOUNTING.						
44	EMERGENCY EGRESS LIGHT WITH BATTERY BACK-UP. COORD. W/ LIGHTING LIGHTING FIXTURE SCHEDULE FOR TYPE AND MOUNTING.						
PNL	ELECTRICAL PANEL.						
Ф	THERMOSTAT LOCATED AT 4'-0" A.F.F.						
TV	PRE-WIRED CABLE TV OUTLET W/ CABLE. COORDINATE LOCATIONS W/ TENANT.						
S	WALL OR CEILING MOUNTED, SMOKE DETECTOR PER CODE.						
IJ	JUNCTION BOX						
Þ	COMMUNICATIONS/DATA (C/D) OUTLET. MOUNT AT 18" A.F.F. PROVIDE EMPTY 4"X4" DEVICE BOX. PROVIDE 1" C. RUN CONDUIT AND CAT 6 WIRE TO PHONE TAB AND TURN INTO CEILING SPACE. OWNER TO PROVIDE COMMUNICATIONS/DATA CONDUCTORS AND EQUIPMENT. CONTRACTOR TO PROVIDE PULL LINE AND END BUSHINGS. (C = 6" ABOVE COUNTERTOP)						
€WH	ELECTRIC WATER HEATER, COORD. W/ PLUMBING PLANS.						
AHU	HVAC UNIT. COORD. W/ MECHANICAL PLAN. AND HVAC CONTRACTOR						

ALL KITCHEN OUTLETS SHALL BE GFI ALL DATA WIRING SHALL BE RAN IN CONDUIT

ELECTRICAL KEY NOTES

- AHU 1 W/ DISCONNECT AT LOWERED CEILING
- 2 ELECTRIC WATER HEATER W/ DISCONNECT AT LOWERED CEILING / MECHANICAL PLATFORM ABOVE
- 3 22" X 30" ACCESS HATCH AT LOWERED CEILING / MECHANICAL PLATFORM. COORD. W/ MECHANICAL PLAN

THE KITCHEN EQUIPMENT PLANS, INCLUDING THE KITCHEN EXHAUST HOOD, FRESH AIR, FIRE SUPPRESSION SYSTEM, FANS, ETC., IS DIAGRAMMATIC ONLY. THE RESPECTIVE ELECTRICAL, MECHANICAL, AND PLUMBING SUB-CONTRACTORS SHALL BE RESPONSIBLE FOR OBTAINING FLORIDA ENGINEER-CERTIFIED DRAWINGS SUCH SUB-CONTRACTORS SHALL BE RESPONSIBLE FOR PROFESSIONAL INSTALLATION.

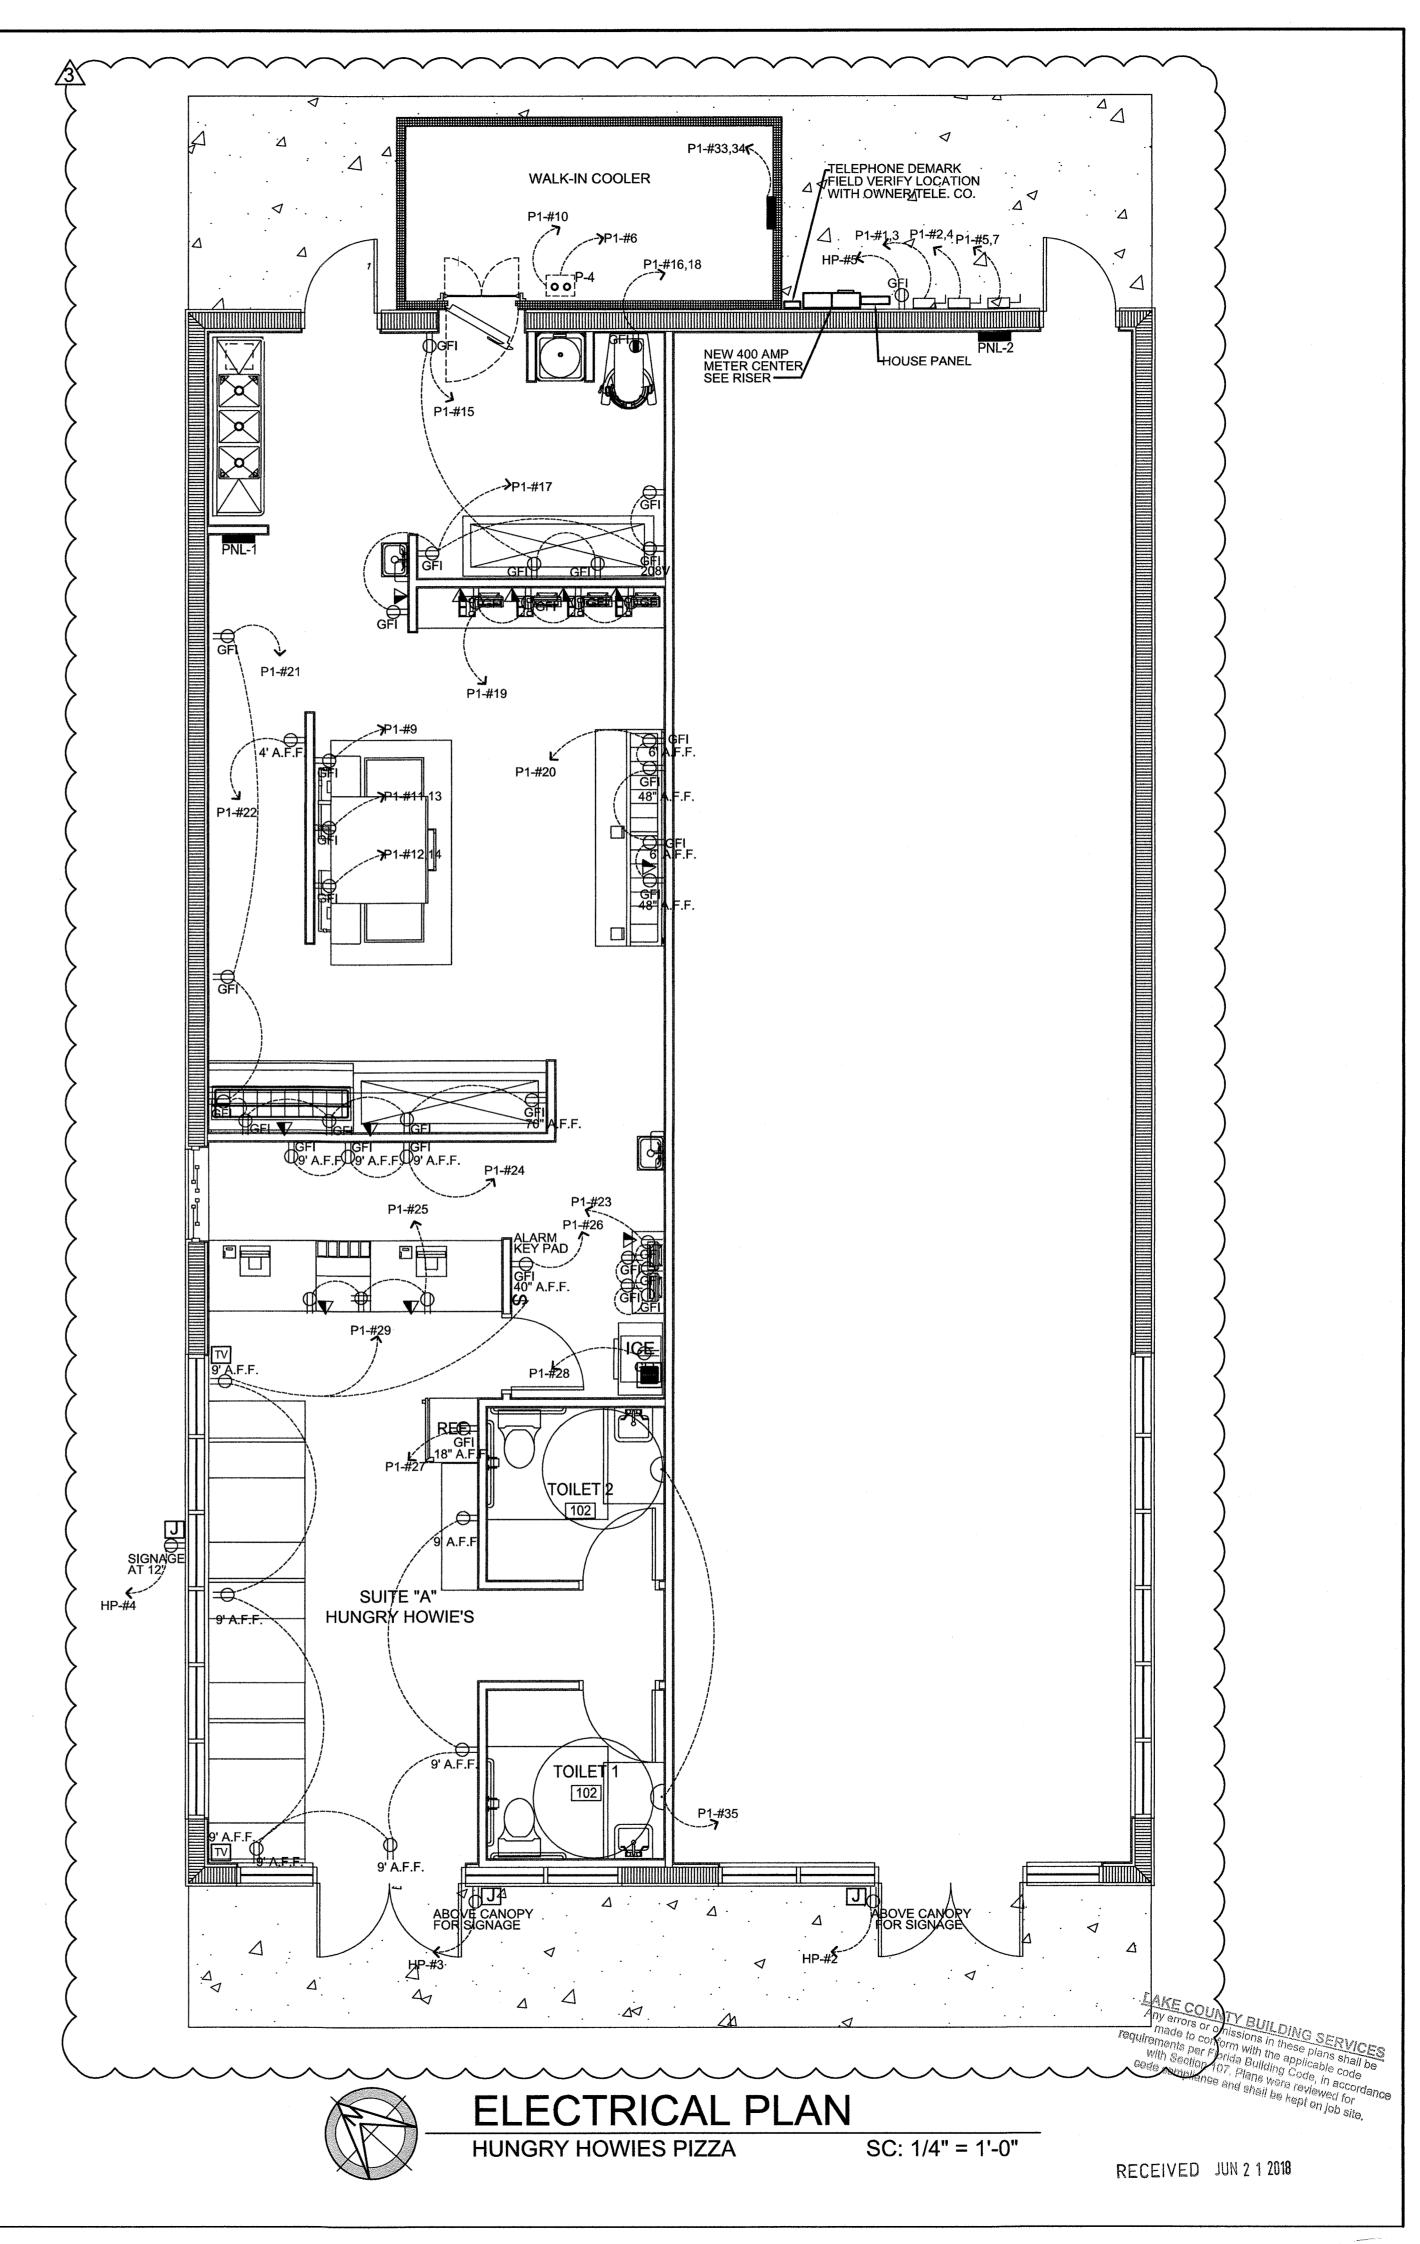

HUNGRY HOWIES PIZZA AND SHELL CONSTRUC 3872027 SUNRISE PLAZA DR., CLERMONT, FLOI

RASSOCATES 1960-C Buford Blvd. Tallahassee, Florida 32308 Thone/Fax: 850-878-8784

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FEB. 13, 2018

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REVISED

MAR. 26, 2018

JUNE 12, 2018


JOB NO.

17-265

DATE 06-12-2018

SHEET NUMBER

E1.0

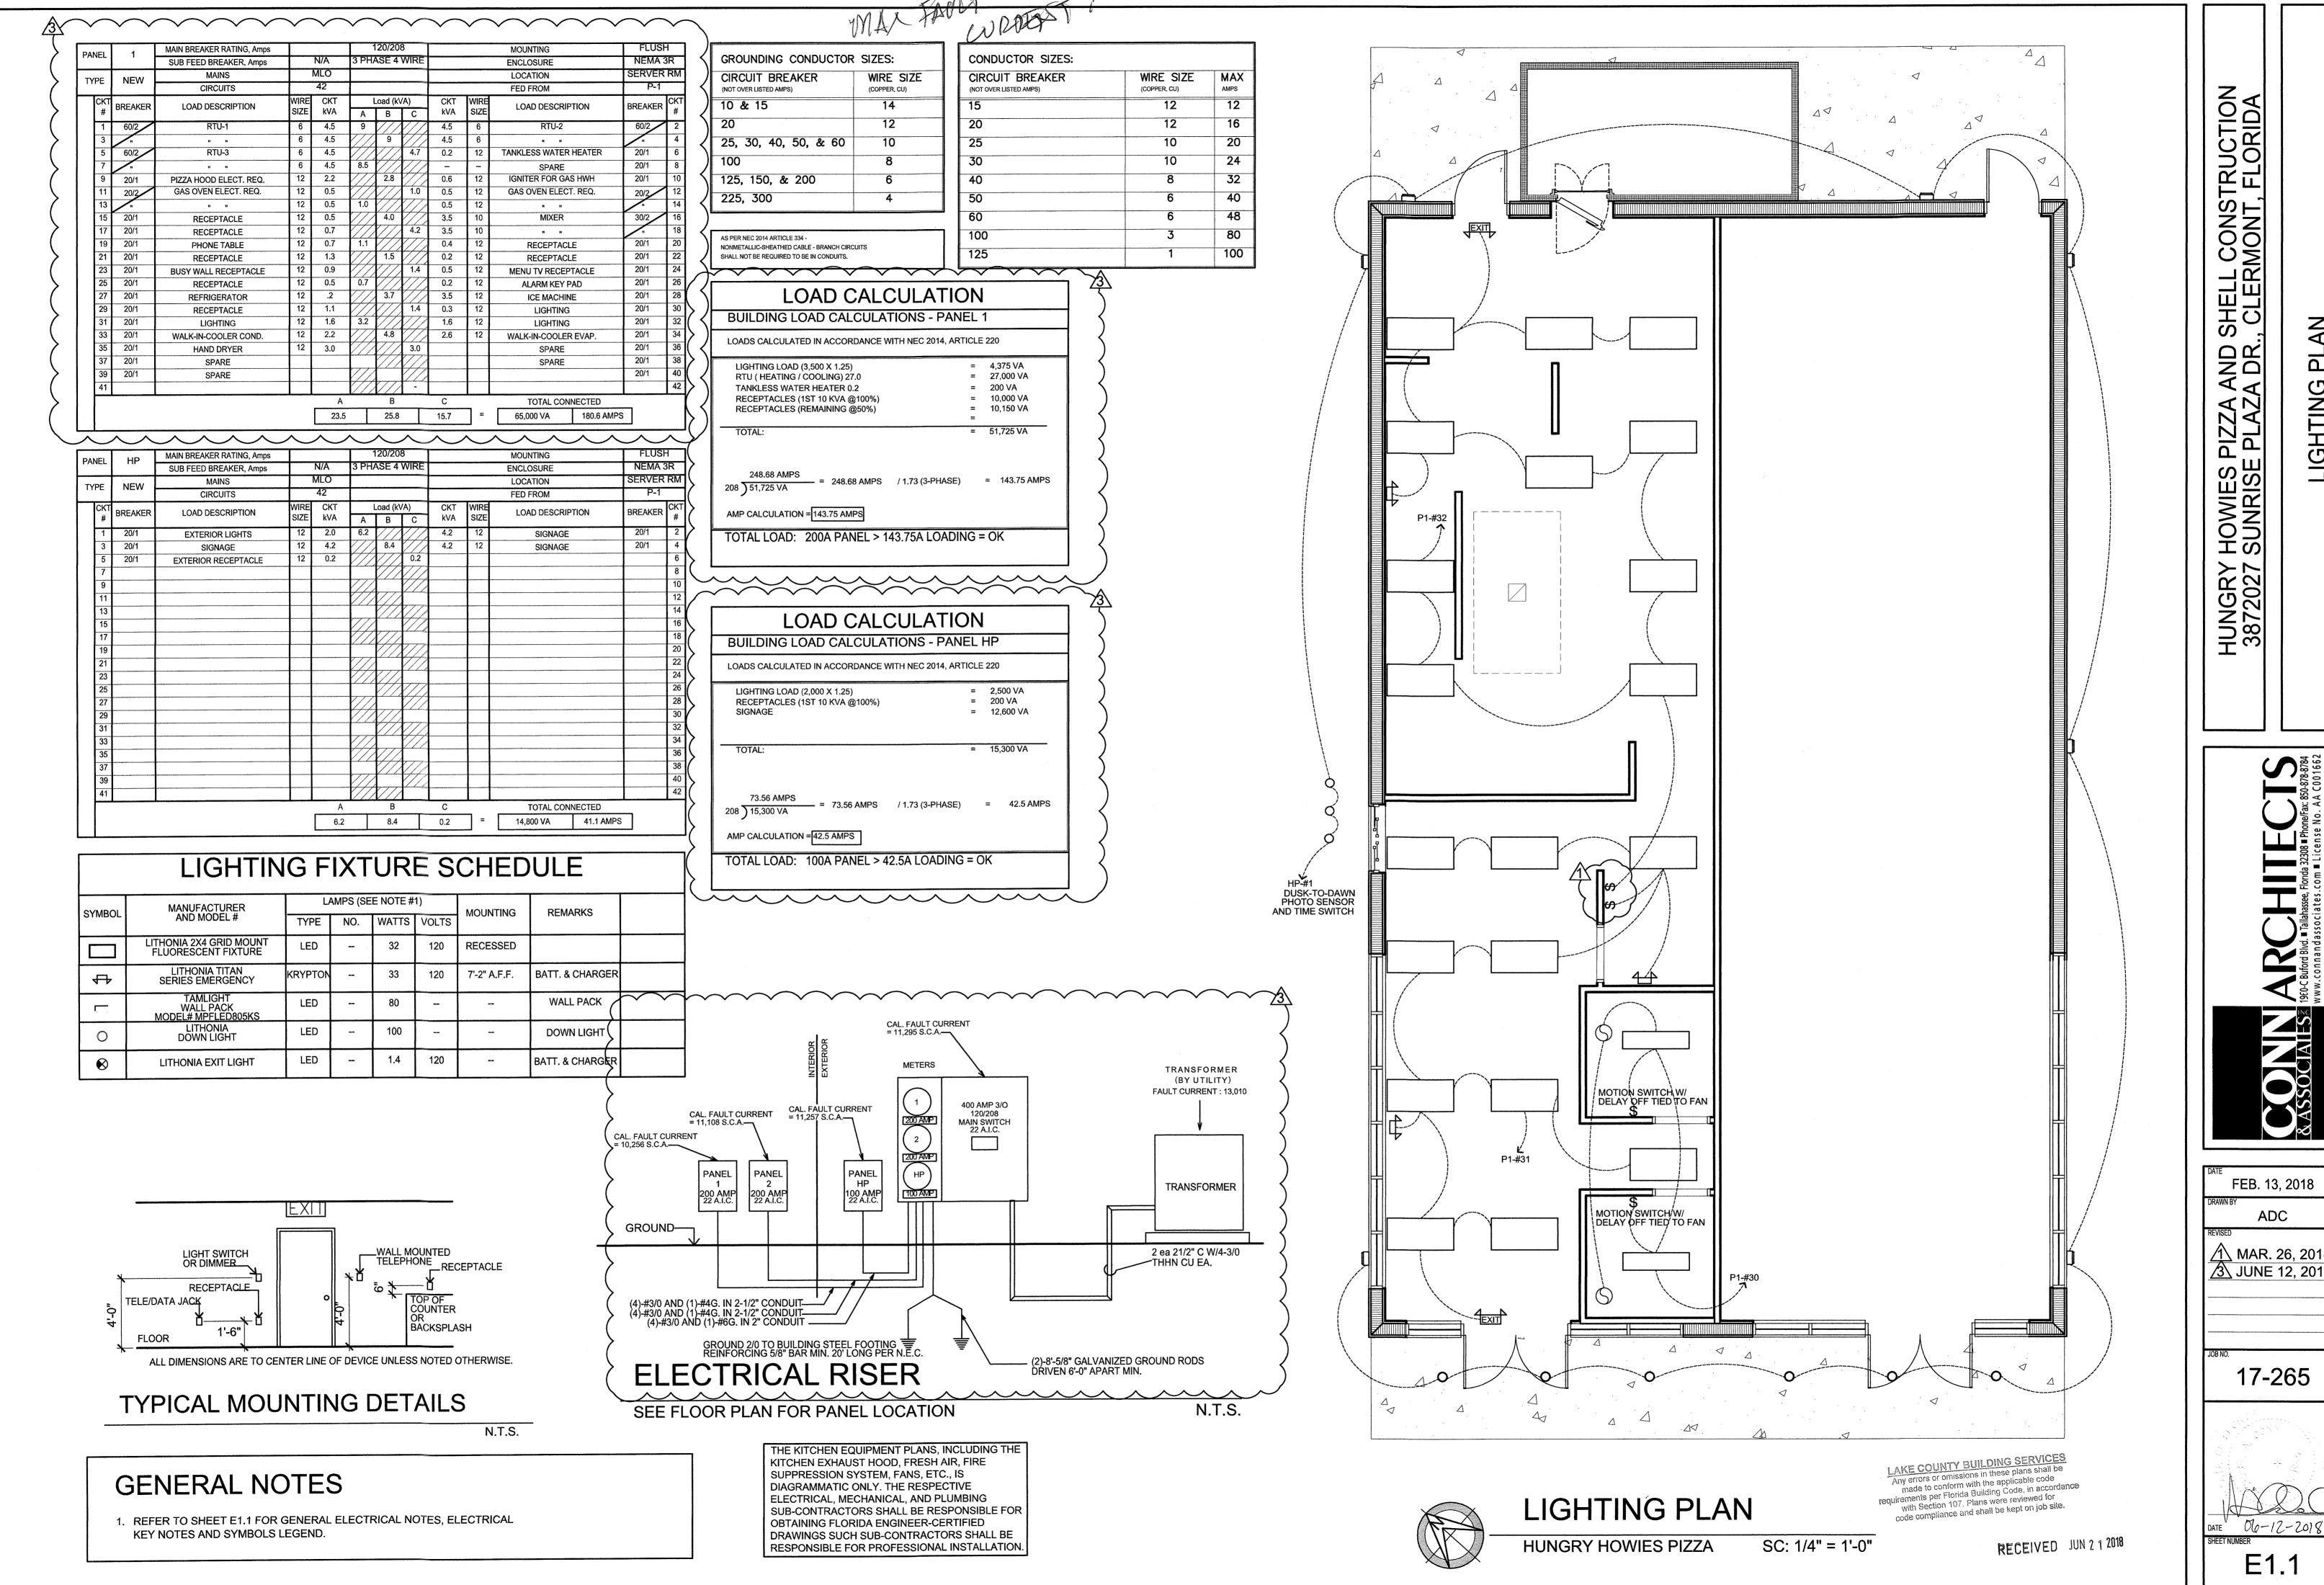

/1\ MAR. 26, 2018 3 JUNE 12, 2018 1 FIRE EXTINGUISHER PER 3,000 SQ.FT.

1,225/3,000 = 1 FIRE EXTINGUISHERS MINIMUM REQUIRED. SEE OVERALL PLANS FOR LOCATION OF 2A10BC (MIN.) FIRE EXTINGUISHER.

F.E. PLACE AS PLAN INDICATES OR ALONG PATH OF TRAVEL DISPERSED EVENLY ACROSS BUILDING.

OCCUPANCY CLASSIFICATION - NEW BUSINESS

REFER TO CHAPTER 38 (NEW BUSINESS OCCUPANCIES) 1 EXITS REQUIRED, PER F.F.P.C. 38.2.4.3 2 EXITS PROVIDED

OCCUPANT LOAD

TOTAL AREA - 1,225 S.F.

UN-CONCENTRATED (TABLES AND CHAIRS)-15 NET 419 SQ. FT. = 27.9=28

BUSINESS AREA

67 SQ. FT. = .67=1

KITCHENS

582 SQ. FT. = 2.91=3

TOTAL OCCUPANT LOAD =

32 PEOPLE

EMERGENCY EGRESS

REQUIRED EMERGENCY EGRESS CAPACITY

AT LEVEL EXIT COMPONENTS AND RAMPS -0.2" EGRESS WIDTH PER PERSON (NEW BUSINESS - TABLE 7.3.3.1,

NFPA 101-06 - FLORIDA FIRE PREVENTION CODE, 6th ED.

36" MINIMUM CLEAR WIDTH FOR H/C ACCESSIBLE EGRESS

PROVIDED EMERGENCY EGRESS MINIMUM CLEAR CORRIDOR WIDTH - 5'-0" (60")

44.0" / 0.2" = 220 <u>220 PERSON</u> CAPACITY

CLEAR SINGLE DOOR OPENING WIDTH - 3'-0" (36")

34" / 0.2" = 170 <u>170 PERSON</u> CAPACITY

TRAVEL DISTANCE REQUIREMENTS

MAXIMUM TRAVEL DISTANCE TO EXIT = 250 FEET FOR

NON-SPRINKLERED BUILDING

ACTUAL MAXIMUM TRAVEL DISTANCE TO EXIT

APPROXIMATELY 58'-10"


FIRE PROTECTION NOTES

- 1. SEE COVER SHEET G1.0 FOR PROJECT INFORMATION.
- 2. ALL FIRE AND/OR SMOKE BARRIERS OR WALL SHALL BE EFFECTIVELY PERMANENTLY IDENTIFIED WITH STENCILING ABOVE ANY DECORATIVE CEILING AND/OR IN CONCEALED SPACE WITH LETTERS A MINIMUM OF (2) TWO INCHES HIGH ON A CONTRASTING BACKGROUND SPACED A MAXIMUM OF TWELVE (12) FEET ON CENTER WITH A MINIMUM OF ONE PER WALL OR BARRIER. THE HOURLY FIRE RATING SHALL BE INCLUDED ON ALL RATED BARRIER OR WALLS. REQUIRED WORDING '() HOUR FIRE AND SMOKE BARRIER-PROTECT ALL OPENINGS STORAGE ROOMS WHICH ARE SPRINKLERED SHALL HAVE STENCILED 18" BELOW SPRINKLER HEADS A DESIGNATION LINE (RED) WITH THE FOLLOWING NOTE- "NO STORAGE ABOVE LINE".
- 3. THE FIRE EXTINGUISHERS FOR THIS PROJECT A TO BE U.L. RATED 2-A:10-B:C
- 4. THE FIRE EXTINGUISHERS FOR THIS PROJECT A TO BE U.L. RATED CLASS K IN KITCHEN AREA.

	DOOR SCHEDULE								
NO.	DOOR TYPE	SIZE	LABEL	FRAME TYPE	FIRE RATE	HARDWARE			
100	D	6'-0" X 7'-0"	N/A	ALUM.	N/A	MANUF. STANDARD			
101	A	3'-0" X 7'-0"	N/A	H.M.	N/A	2			
102	T A	3'-0" X 7'-0"	N/A	H.M.	N/A	1			
103	С	3'-0" X 7'-0"	N/A	H.M.	N/A	3			
104a	D	6'-0" X 7'-0"	N/A	ALUM.	N/A	MANUF. STANDARD			
104b	В	3'-0" X 7'-0"	N/A	H.M.	N/A	3			

								A OTUDEDO LIGED		<i>(</i>
CHEDULE			HARI	OWARE SCHEDULE	E '	CODE	ACTURERS USED: MANUFACTURER			
FRAME FIRE LIABRIMARE	MARK	QTY	ITEM	MODEL NUMBER	FINISH	MFG.	HA BES	HAGER HINGE BEST ACCESS SYSTEMS		
TYPE RATE HARDWARE		3	HINGES	BB1279 4 1/2 X 4 1/2	US26D	НА	CR	CORBIN RUSWIN		
ALUM. N/A MANUF. STANDARD		1	PRIVACY LOCKSET	5K 0R 15 STL 626	US26D	BES	BAL	BALDWIN	ľ	· · · · · · · · · · · · · · · · · · ·
H.M. N/A 2		1	CLOSER	DC3200-A1-626-(RH/LH)-M54	US26D	CR	VD	VON DUPRIN		
H.M. N/A 1	'	1	STOP	236 W	US32D	HA	DA	DORMA		
H.M. N/A 3		3	SILENCERS	307D	GREY	HA	HES	HES ASSA ABLOY		1 . 4 .
ALUM. N/A MANUF. STANDARD		2	KICKPLATE	190S-8" X 30"	US32D	HA	L			
H.M. N/A 3		3	HINGES	BB1279 4 1/2 X 4 1/2	US26D	НА				A A
	2	1 1	PASSAGE LOCKSET	5K-0-N-15-C-STK-626	US26D	BES				
		1	STOP	236 W	US32D	HA				L
		2	SILENCERS	307D	GREY	HA				
			KICKPLATE	190S-8" X 30	US32D	НА				
		3	HINGES	BB1279 4 1/2 X 4 1/2	US26D	НА				
	3	1	PUSH PLATE	2280-150	SATIN NICKEL	1 1				
		3	PULL	2355-150	SATIN NICKEL	BAL				
			DEADBOLT	3114	US26D	HA				
			SILENCERS	307D	GREY	НА				
		$\overline{}$					✓			\\\\\\\\\\\\\\\\\\\\\\\\\\\\\\\\\\\\\\

MANUFA	ACTURERS USED:
CODE	MANUFACTURER
HA	HAGER HINGE
BES	BEST ACCESS SYSTEMS
CR	CORBIN RUSWIN
BAL	BALDWIN
VD	VON DUPRIN
DA	DORMA
HES	HES ASSA ABLOY

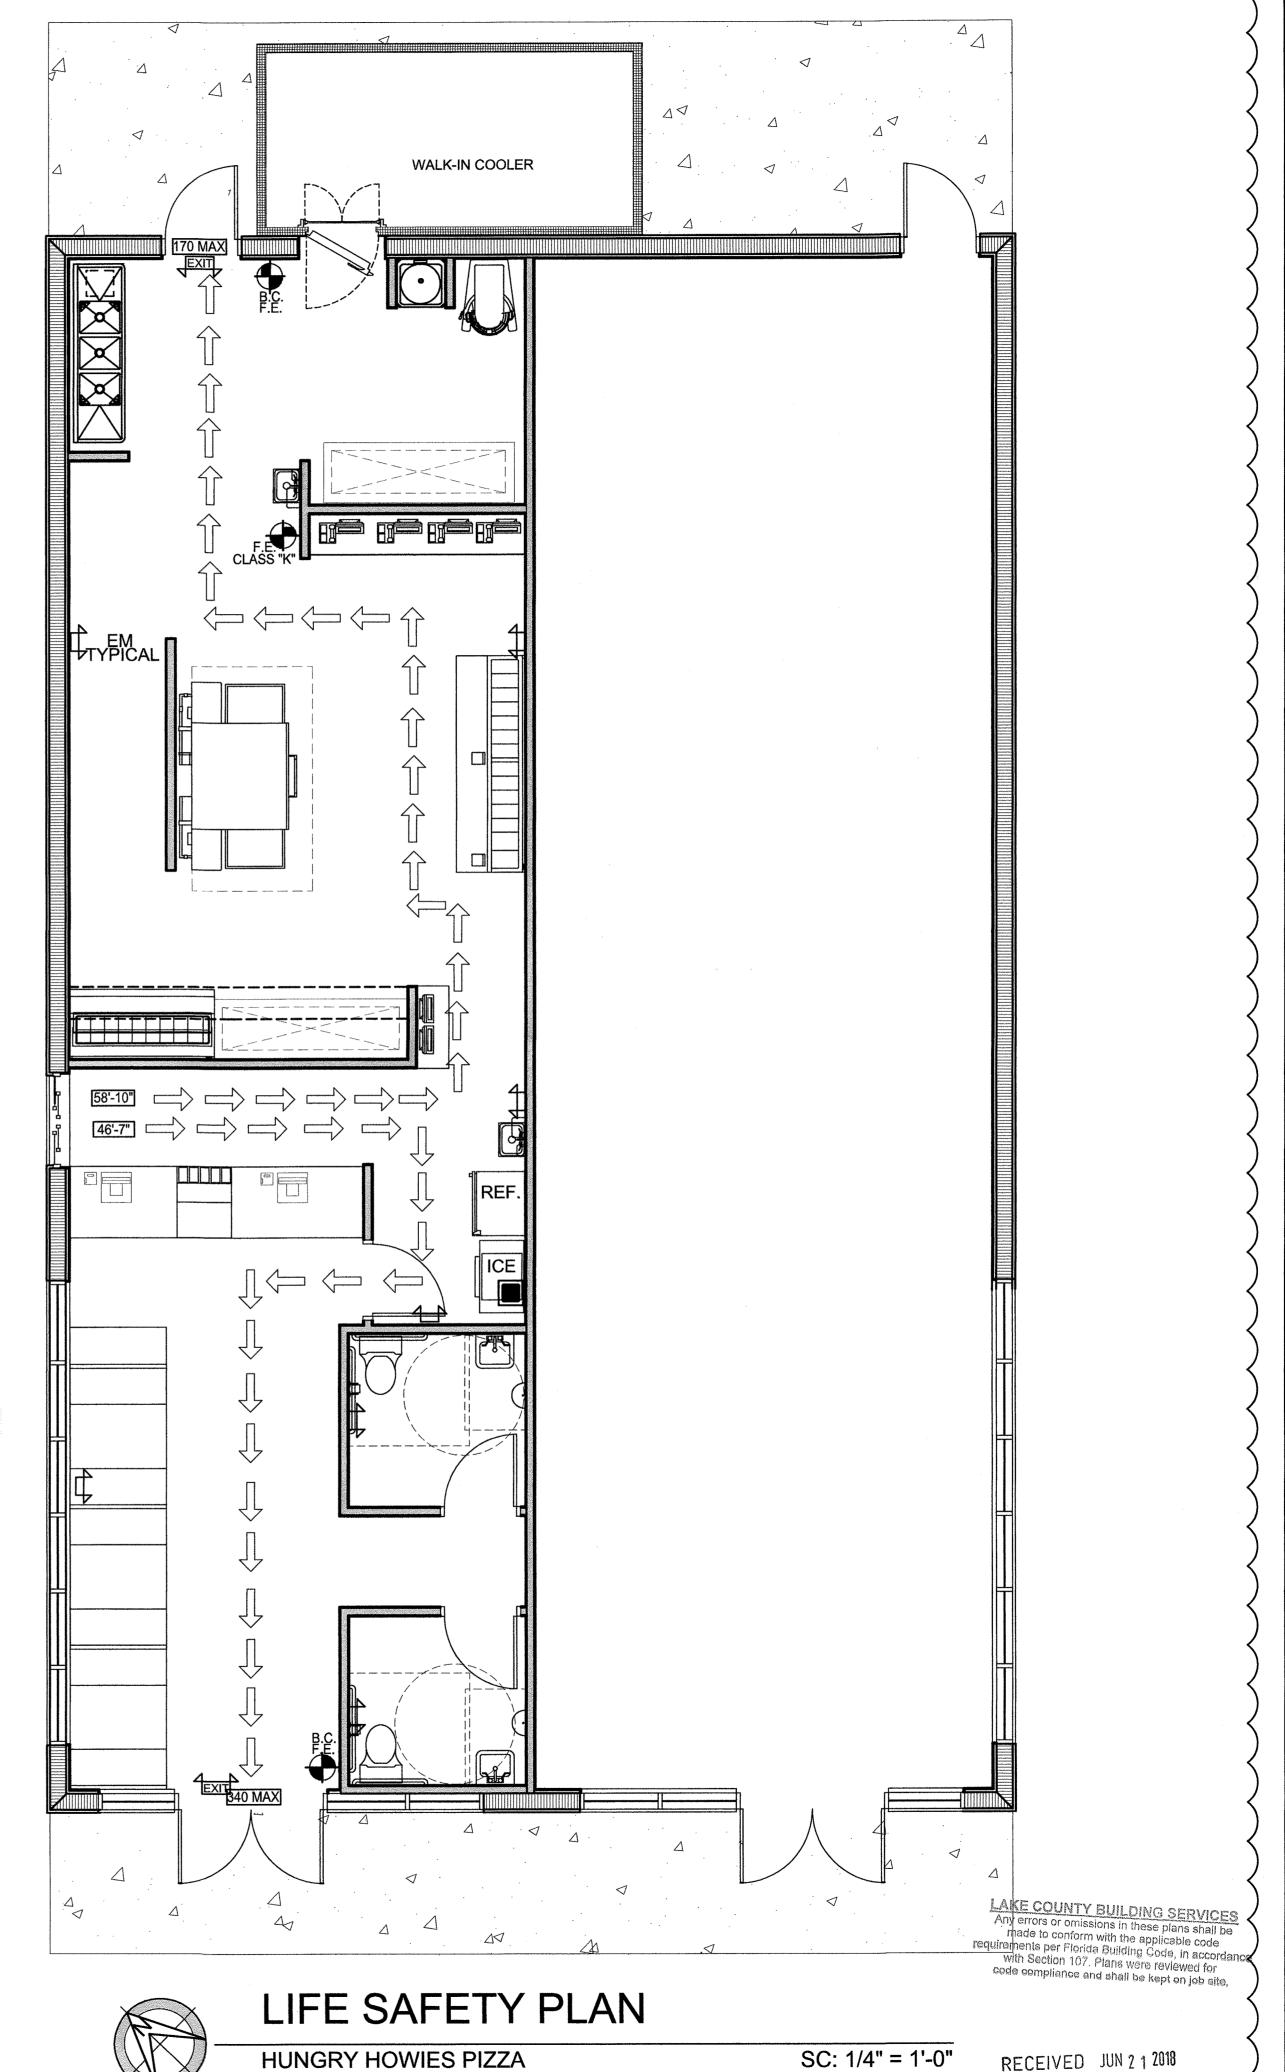

SHELL CONSTRUCTION, CLERMONT, FLORIDA AND A DR.

FEB. 13, 2018 ADC 3 JUNE. 12, 2018 17-265 DATE 06-12-2018 LS1.0