SAWGRASS BAY BLVD MULTILANE ROUNDABOUT

LANDSCAPE / IRRIGATION / LIGHTING 100% CONSTRUCTION DOCUMENTS

PROJECT NO. 240004 MAY 2024

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LD2-1 to LD2-4	SITE PLAN AREA 1 TO 4
LD6-0	DETAILS





4767 New Broad Street, Orlando, FL, 32814 Ph. 407.202.8387



SPADE IRRIGATION DESIGN 307 DUBSDREAD CIRCLE ORLANDO, FL 32804 PHONE: (407) 702-3063





VICINITY MAP SEC. 24, TWP. 24 S, RNG. 26 E

LAKE COUNTY DEPARTMENT OF PUBLIC WORKS ENGINEERING DIVISION 350 N. SINCLAIR AVENUE TAVARES, FLORIDA 32778 PHONE: (352) 253-6000

GENERAL NOTES

- 1. THE CONTRACTOR SHALL BECOME FAMILIAR WITH THE PROJECT SITE PRIOR TO BIDDING THE WORK. THE CONTRACTOR SHALL FIELD VERIFY ALL EXISTING CONDITIONS AND LOCATION OF PROPOSED IMPROVEMENTS PRIOR TO INITIATING ANY CONSTRUCTION.
- LOCATION OF ALL UTILITIES AND BASE INFORMATION IS APPROXIMATE. CONTRACTOR SHALL 2. VERIFY ALL UNDERGROUND UTILITIES AND OBSTRUCTIONS PRIOR TO INITIATING WORK. CONTRACTOR SHALL BE RESPONSIBLE FOR REPAIR OR REPLACEMENT OF ANY DAMAGE TO EXISTING ELEMENTS ABOVE OR BELOW GROUND TO ITS ORIGINAL CONDITION AND TO THE SATISFACTION OF THE OWNER'S REPRESENTATIVE.
- 3. THE OWNER'S REPRESENTATIVE SHALL HAVE THE RIGHT, AT ANY STAGE OF THE OPERATIONS, TO REJECT ANY AND ALL WORK AND MATERIAL WHICH, IN HIS OPINION, DO NOT MEET WITH THE REQUIREMENTS OF THESE PLANS AND SPECIFICATIONS.
- CONTRACTOR SHALL VERIFY ALL GRADES, DIMENSIONS, AND EXISTING CONDITIONS ON THE JOB 4 SITE PRIOR TO START OF CONSTRUCTION AND/OR FABRICATION. CONTRACTOR SHALL NOTIFY OWNER'S REPRESENTATIVE OF ANY VARIATIONS FROM THE DIMENSIONS AND CONDITIONS SHOWN ON THESE DRAWINGS.
- REPORT ANY DISCREPANCIES BETWEEN THE CONSTRUCTION DRAWINGS AND FIELD CONDITIONS 5. TO THE OWNER'S REPRESENTATIVE.
- THE CONTRACTOR SHALL PROVIDE ALL NECESSARY SAFETY MEASURES DURING CONSTRUCTION 6 OPERATIONS TO PROTECT THE PUBLIC ACCORDING TO ALL APPLICABLE CODES AND RECOGNIZED LOCAL PRACTICES.
- 7. THE CONTRACTOR SHALL COORDINATE ACCESS AND STAGING AREAS WITH THE OWNER'S REPRESENTATIVE. THE CONTRACTOR SHALL MAINTAIN ALL EXISTING EROSION AND SEDIMENTATION CONTROL MEASURES DURING CONSTRUCTION. PROVIDE ADDITIONAL MEASURES AS NECESSARY TO MINIMIZE ADVERSE IMPACTS IN ACCORDANCE WITH ALL APPLICABLE FEDERAL, STATE, AND LOCAL CODES.
- NO SUBSTITUTIONS SHALL BE MADE WITHOUT WRITTEN CONSENT OF THE OWNER'S 8. REPRESENTATIVE. DURING THE COURSE OF THIS WORK, EXCESS WASTE MATERIAL SHALL BE REMOVED DAILY FROM THE SITE.
- 9 THE CONTRACTOR SHALL BE RESPONSIBLE FOR SCHEDULING AND COORDINATION OF WORK WITH OTHER TRADES AND THE OWNER'S REPRESENTATIVE.
- 10. THE CONTRACTOR SHALL NOTIFY ALL NECESSARY UTILITY COMPANIES 48 HRS MINIMUM PRIOR TO DIGGING FOR FIELD VERIFICATION OF ALL UNDERGROUND UTILITIES. UTILITY LOCATING SHALL BE SCHEDULED BY THE CONTRACTOR WITH OWNER'S REPRESENTATIVE PRESENT.
- 11. UTILITIES TO BE LOCATED BY FLAGGING ONLY; PAINTING OF HARDSCAPE AREAS IS PROHIBITED. CONTRACTOR SHALL BE RESPONSIBLE FOR NOTIFYING UTILITY LOCATING COMPANIES OF THIS REQUIREMENT.
- ALL EXISTING SITE ROADS, PARKING LOTS, CURBS, UTILITIES, SEWERS, AND OTHER ELEMENTS TO 12. REMAIN SHALL BE FULLY PROTECTED FROM ANY DAMAGE UNLESS OTHERWISE NOTED.
- 13. NOT ALL ITEMS SHOWN ON THIS SHEET APPEAR IN THE CONSTRUCTION DOCUMENTS. CONTRACTOR IS RESPONSIBLE FOR OBTAINING ALL PERMITS RELATED TO CONSTRUCTION INCLUDING, BUT NOT LIMITED TO: BUILDING, LANDSCAPE, IRRIGATION AND RIGHT-OF-WAY UTILIZATION PERMITS.

LANDSCAPE NOTES

- 1. THE CONTRACTOR SHALL REVIEW PLANS TO BECOME THOROUGHLY FAMILIAR WITH SURFACE AND SUBSURFACE UTILITIES.
- THE PLANT QUANTITIES SHOWN ON THE LANDSCAPE CONTRACT DOCUMENTS ARE FOR THE 2. CONVENIENCE OF THE CONTRACTOR. THE CONTRACTOR IS RESPONSIBLE FOR VERIFYING ALL QUANTITIES AND REPORTING ANY DISCREPANCIES TO THE LANDSCAPE ARCHITECT FOR CLARIFICATION PRIOR TO CONTRACT AWARD AND COMMENCEMENT OF WORK.
- ALL INSTALLATION OF PLANT MATERIAL SHALL COMPLY WITH APPLICABLE JURISDICTIONAL 3. CODES. THE CONTRACTOR IS RESPONSIBLE FOR OBTAINING ALL PERMITS ASSOCIATED WITH THIS WORK.

- 4. PRIOR TO PLANTING INSTALLATION, THE CONTRACTOR SHALL CONFIRM THE AVAILABILITY OF ALL THE SPECIFIED PLANT MATERIALS. SUBMIT DATED PHOTOGRAPHS OF ALL TREE MATERIAL AND SPECIMEN MATERIAL AS TO THE OWNER'S REPRESENTATIVE FOR REVIEW.
- ALL PLANT MATERIAL SIZES SPECIFIED ARE MINIMUM SIZES. CONTAINER SIZE SHALL BE INCREASED 5. IF NECESSARY TO PROVIDE OVERALL PLANT SIZE SPECIFIED.
- IF PLANT MATERIAL DOES NOT COMPLY WITH THE REQUIREMENTS AS SPECIFIED HEREIN, THE 6. OWNER'S REPRESENTATIVE RESERVES THE RIGHT TO REJECT SUCH PLANTS AND REQUIRE THE CONTRACTOR TO REPLACE REJECTED WORK AND CONTINUE SPECIFIED MAINTENANCE UNTIL **RE-INSPECTED AND FOUND TO BE ACCEPTABLE.**
- THE CONTRACTOR SHALL PROVIDE AN APPROVED PLANTING SOIL MIXTURE FOR ALL PLANT 7. MATERIAL. SEE SPECIFICATIONS FOR REQUIREMENTS.
- THE CONTRACTOR SHALL BE RESPONSIBLE FOR STABILITY AND PLUMB CONDITION OF ALL TREES 8. AND SHRUBS, AND SHALL BE LEGALLY LIABLE FOR ANY DAMAGE CAUSED BY INSTABILITY OF ANY PLANT MATERIALS. STAKING OF TREES OR SHRUBS SHALL BE DONE IN ACCORDANCE WITH PLANS AND SPECIFICATIONS.
- 9. THE CONTRACTOR SHALL INSURE ADEQUATE VERTICAL DRAINAGE IN ALL PLANT BEDS AND PLANTERS. IF INADEQUATE VERTICAL DRAINAGE IS ENCOUNTERED, THE CONTRACTOR SHALL SUBMIT RECOMMENDATIONS FOR PROVIDING ADEQUATE DRAINAGE TO THE OWNER'S REPRESENTATIVE.
- 10. PEG SOD ON SLOPES GREATER THAN 3:1.
- 11. CONTRACTOR SHALL PROTECT EXISTING VEGETATION TO REMAIN AS SHOWN ON DRAWINGS OR BY MEANS APPROVED BY THE OWNER'S REPRESENTATIVE.
- CONTRACTOR TO CLEAN, PRUNE, AND SHAPE EDGES OF EXISTING VEGETATION AS DIRECTED BY 12 OWNER'S REPRESENTATIVE. CREATE SMOOTH BED LINES AROUND EXISTING VEGETATION.
- 13. THE CONTRACTOR SHALL BEAR ALL COSTS OF TESTING OF SOILS, AMENDMENTS, ETC. ASSOCIATED WITH THE WORK. SEE SPECIFICATIONS FOR ADDITIONAL TESTING REQUIREMENTS.
- 14. CONTRACTOR SHALL FIELD-ADJUST LOCATION OF PLANT MATERIAL PRIOR TO INITIATING INSTALLATION FOR THE REVIEW AND APPROVAL OF THE OWNER'S REPRESENTATIVE.
- 15. ALL PLANT MATERIAL SHALL BE IN FULL AND STRICT ACCORDANCE WITH FLORIDA NO. 1 GRADE, ACCORDING TO THE "GRADES AND STANDARDS FOR NURSERY PLANTS" PUBLISHED BY THE FLORIDA DEPARTMENT OF AGRICULTURE AND CONSUMER SERVICES.
- 16. ALL PLANTING BEDS SHALL BE TOP-DRESSED WITH A 3" LAYER OF MULCH AS SPECIFIED.
- 17. CONTRACTOR SHALL COORDINATE ALL PLANTING WORK WITH IRRIGATION WORK. CONTRACTOR SHALL BE RESPONSIBLE FOR ALL HAND WATERING AS REQUIRED TO SUPPLEMENT IRRIGATION WATERING AND RAINFALL.
- 18. CONTRACTOR SHALL BE RESPONSIBLE FOR HAND WATERING IN ALL PLANTING AREAS, REGARDLESS OF THE STATUS OF EXISTING OR PROPOSED IRRIGATION.
- CONTRACTOR SHALL RE-GRADE ALL AREAS DISTURBED BY PLANT REMOVAL, RELOCATION, 19. AND/OR INSTALLATION WORK.
- 20. CONTRACTOR SHALL REPLACE (BY EQUAL SIZE AND QUALITY) ANY AND ALL EXISTING PLANT MATERIAL DISTURBED OR DAMAGED BY PLANT REMOVAL, RELOCATION, AND/OR INSTALLATION WORK.
- 21. CONTRACTOR SHALL BE RESPONSIBLE TO MAINTAIN LANDSCAPE AND IRRIGATION FOR ONE YEAR AFTER COUNTY'S ACCEPTANCE. MAINTENANCE INCLUDES WATERING, PRUNING, WEEDING, MULCHING, REPLACEMENTS OF SICK OR DEAD PLANTS, AND ANY OTHER CARE NECESSARY FOR THE PROPER GROWTH OF THE PLANT MATERIAL.
- 22. UPON COMPLETION OF ALL LANDSCAPING, AN INSPECTION FOR SUBSTANTIAL COMPLETION OF THE WORK SHALL BE HELD. THE CONTRACTOR SHALL NOTIFY THE OWNER'S REPRESENTATIVE FOR SCHEDULING THE INSPECTION AT LEAST SEVEN (7) DAYS PRIOR TO THE ANTICIPATED INSPECTION DATE.
- 23. CONTRACTOR SHALL SUBMIT WRITTEN GUARANTEE OF SURVIVABILITY OF ALL PLANT MATERIAL FOR A PERIOD OF ONE YEAR FROM DATE OF FINAL COMPLETION.
- CONTRACTOR MUST REVIEW AND ACCEPT, APPROVE ALL GRADED AREAS PRIOR TO THE 24. COMMENCEMENT OF PLANTING.
- TREES ADJACENT TO BUILDINGS SHOULD BE PLANTED AT LEAST THE DIAMETER OF THE TREE 25. CANOPY OR A MIN. OF 10'-0" (WHICHEVER IS GREATER) AWAY FROM THE BUILDING WALL.
- CONTRACTOR IS RESPONSIBLE FOR THE REPAIR OF ANY EXISTING LAWN AREAS OR PLANTING 26. AREAS DISTURBED DURING THE CONSTRUCTION PROCESS.



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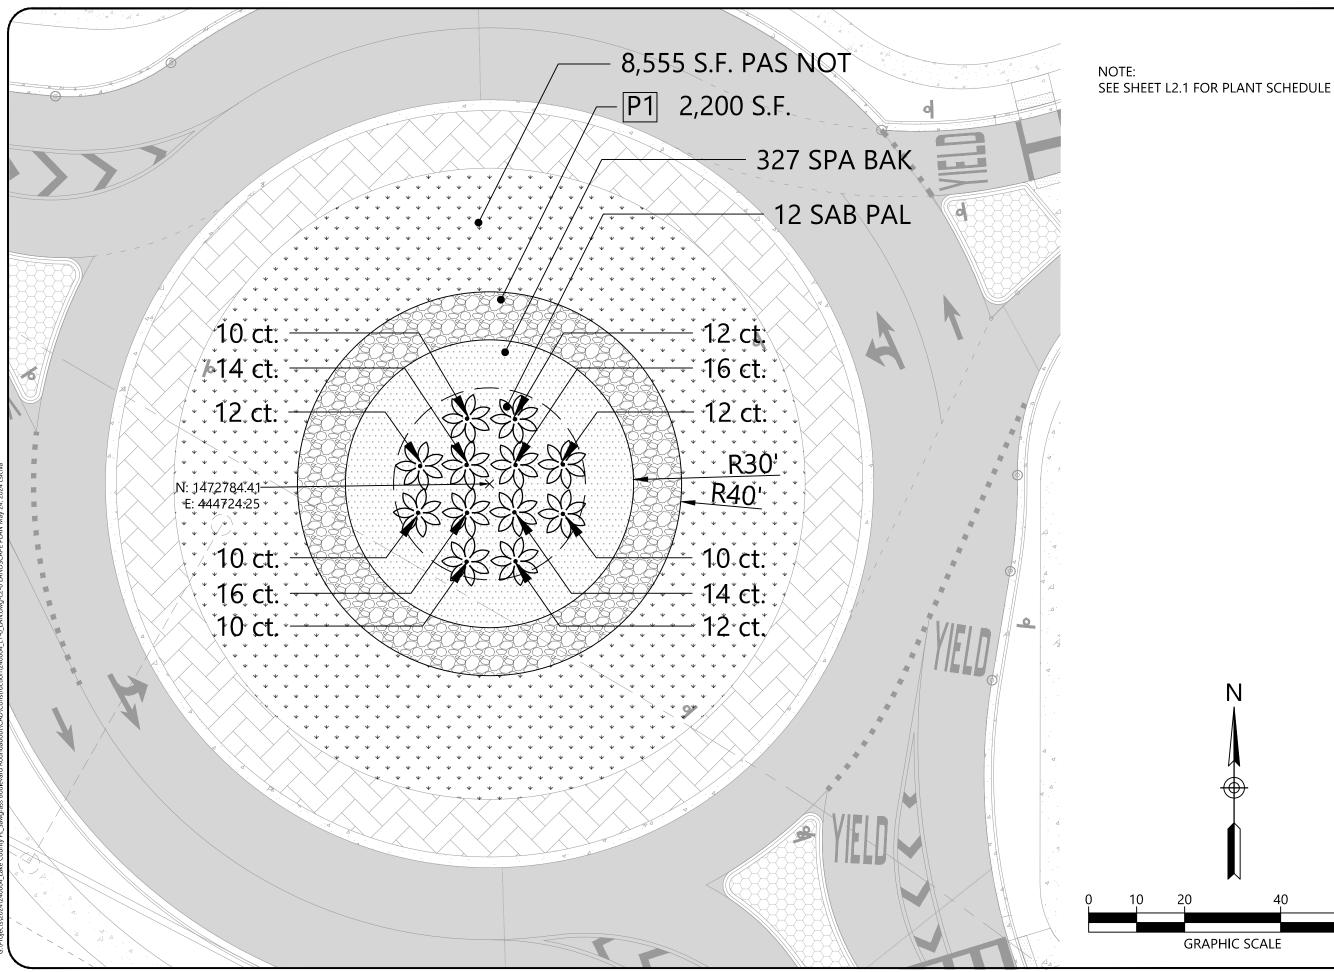
Todd McCurdy, FASLA, PLA 00001084



PROJECT NUMBE 240004

DRAWING NAM LANDSCAPE NOTES

DRAWING NUMBER

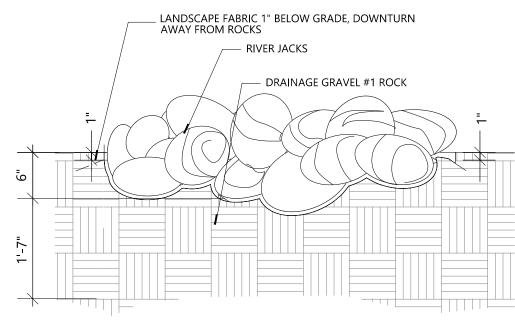




PLANT SCHEE	DULE			
ID	QTY	Botanical name	Common Name	Scheduled Size
SAB PAL	12	Sabal palmetto	Cabbage Palmetto	
SPA BAK	327	Spartina bakeri	Sand Cordgrass	3 gal. 36"o.c.
PAS NOT	8,555 S.F.	Paspalum notatum	Bahia Sod	

FINISH SCHEDULE

TAG	Item/Material	Model/style	Dimensions	Supplier	Note
P1	River Jacks	2470-T	3"-5"	Pebble Junction	



NOTE:

- 1. CONTRACTOR SHALL REMOVE AND ERADICATE ALL EXISTING GRASSES AND WEEDS IN D.S. AREAS AS REQUIRED WITH ROUND-UP OR OTHER APPROVED HERBICIDE.
- 2. SUB-GRADES SHALL BE THOROUGHLY COMPACTED BEFORE GRAVEL IS INSTALLED.
- 3. GRAVEL SHALL BE SPREAD TO A MINIMUM DEPTH OF 5", RAKED, DAMPENED, ROLLED AND BROOMED TO AN EVEN FINISH.
- 4. AGGREGATE SHALL BE RINSED THOROUGHLY TO REMOVE DEBRIS.
- 5. CONTRACTOR SHALL APPLY PRE-EMERGENT HERBICIDE TO WEED-FREE GRAVEL AREAS.

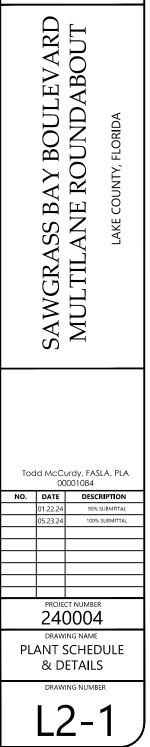
RIVER STONE DETAIL

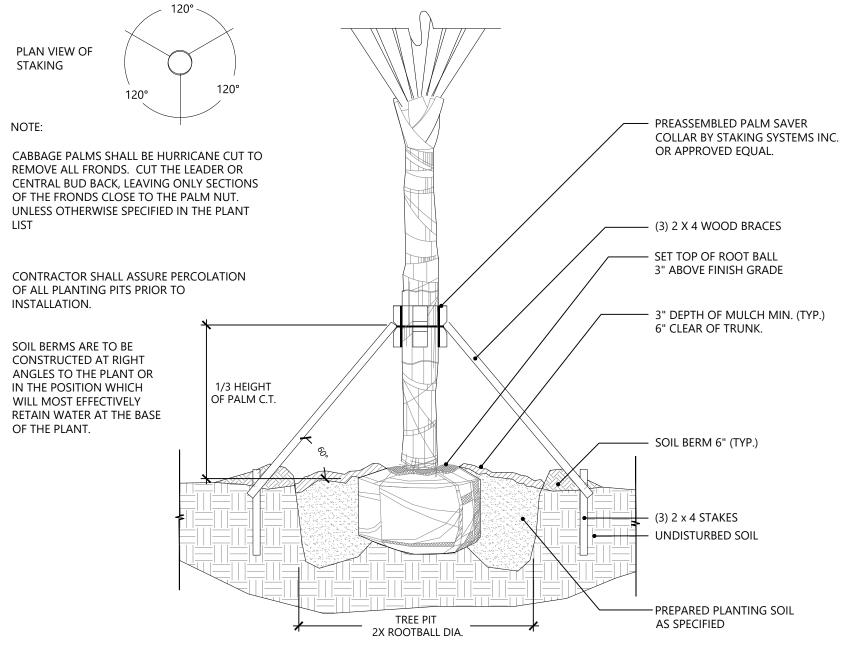
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PALM PLANTING

SCALE: NTS



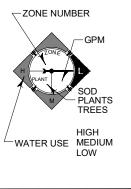
	SAWGRASS BAY BOULEVARI	MULTILANE ROUNDABOUT	LAKE COUNTY, FLORIDA
Tod	ld McCl	urdy, FA	SLA, PLA
NO.	DATE	DES	CRIPTION
	01.22.24		6 SUBMITTAL
	05.23.24	100'	% SUBMITTAL
	PROIE	CT NUMBE	R
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	LAND	ING NAMI DSCAI TAILS	PE
	DRAW	ING NUM	BER
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RECLAIMED WATER REQUIREMENTS

- 1) ALL PIPE SHALL BE THE PURPLE RECLAIMED WATER TYPE.
- 2) ALL SPRINKLER HEADS SHALL HAVE PURPLE INDICATORS.
- 3) ALL MANUAL AND ELECTRIC VALVES SHALL HAVE TAGS TO INDICATE RECLAIMED WATER.
- 4) ALL VALVE BOXES SHALL BE PURPLE WITH PURPLE LIDS TO INDICATE THE PRESENCE OF RECLAIMED WATER.
- 5) ALL EQUIPMENT SHALL BE INSTALLED AS PER ALL LOCAL, COUNTY, STATE, AND FEDERAL CODES. PROVIDE AND INSTALL ALL REQUIRED RECLAIMED WATER SIGNS. COORDINATE PLACEMENT AND TYPE WITH THE RECLAIMED WATER PROVIDER.
- 6) ALL CROSSINGS OF IRRIGATION PIPING AND POTABLE WATER LINES SHALL HAVE THE VERTICAL CLEARANCE VISUALLY VERIFIED AND THIS VERIFICATION MUST BE SHOWN ON THE AS-BUILT DRAWINGS BY DOCUMENTING THE VERTICAL MEASUREMENT SEPARATING THE PIPES.
- 7) THE VERTICAL SEPARATION BETWEEN THE POTABLE AND RECLAIMED WATER LINES SHALL BE A MINIMUM OF 18". THIS SEPARATION SHALL BE VERIFIED AND DOCUMENTED IN A SET OF AS-BUILT DRAWINGS AS PER SPECIFICATIONS. THE HORIZONTAL SEPARATION SHALL BE 5' CENTER TO CENTER AND 3' OUTSIDE TO OUTSIDE IF VERTICAL MINIMUM OF 18" IS NOT MET. REFER TO THE SPECIFIC CODE IF THESE SEPARATIONS CAN NOT BE MET.

NOZZLE CHART

			G.P.M.				
LETTER	R SPEC.	COLOR	40 PSI	DISTANCE	E F	RADIUS	
Α	MP2000	RED	1.47	19'	FULL	360°	
В	MP CORNER	TURQUOISE	.45	14'	CORNER	105°	
С	MP CORNER	TURQUOISE	.19	14'	CORNER	45°	$ \setminus$
D	MP2000	BLACK	.74	19'	HALF	180°	1 `
F	MP2000	BLACK	.40	19'	QUARTER	90°]
G	MP END STRIP	COPPER	.22	5' X 15'	END STRIP		
Н	RAIN. XPCN	BLACK	.23	4.5'	HALF PATTE	ERN	<+
K	MP815	OLIVE	1.87	8'-16'	FULL	360°	∦
М	MP SIDE S	BROWN	.44	5' X 30'	SIDE STRIP		/
S	MP815	MAROON	.49	8'-16'	90°-180°		
Т	MP815	MAROON	.93	8'-16'	90°-180°		/
V	MP3000	BLUE	.86	30'	QUARTER	90 °	/
W	MP3000	BLUE	1.82	30'	HALF	180°	w
Х	MP3000	YELLOW	2.73	30'	THREE QTR	. 270°	
Y	MP3000	GRAY	3.64	30'	FULL	360°	
Z	MP2000	GREEN	1.10	19'	THREE QTR	. 270°	



THE NOZZLES LISTED SHOW THE TYPE OF MP ROTATOR NOZZLE THAT SHOULD BE USED. THE CONTRACTOR SHOULD INSTALL CORRECT NOZZLE IN EACH HEAD AS SHOWN BY THE LETTER BESIDE THE HEAD ON THE PLAN. DO NOT USE MP1000 SERIES NOZZLES. THE GPM, DISTANCE AND ANGLE ON THE NOZZLE CHART ARE APPROXIMATE. THE CONTRACTOR SHALL ADJUST ALL NOZZLES TO PROVIDE THE 100% COVERAGE, BUT LIMIT OVERTHROW ON TO BUILDINGS, WALLS, PAVEMENT, ETC, THE HEADS SHALL BE SPACED AS PER THE PLAN. SCALE THE PLAN FOR DISTANCE. DO NOT ASSUME THAT ALL HEADS ARE SPACED AS PER CONVENTIONAL SPRAY HEADS. THE PRECIPITATION RATE FOR THESE NOZZLES IS LESS THAN A CONVENTIONAL SPRAY NOZZLE. FOLLOW THE ZONE CHART FOR AN APPROXIMATE RUN TIME FOR EACH ZONE, BUT SET THE RUN TIME ON THE CONTROLLER BASED ON THE SPECIFIC SITE CONDITIONS. DO NOT SUBSTITUTE WITH STANDARD NOZZLES.



ZONE LABELS

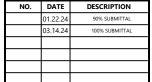


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SS BAY BOULEVARD MULTILANE ROUNDABOUT FLORIDA COUNTY, LAKE SAWGRA

Todd McCurdy, FASLA, PLA 00001084



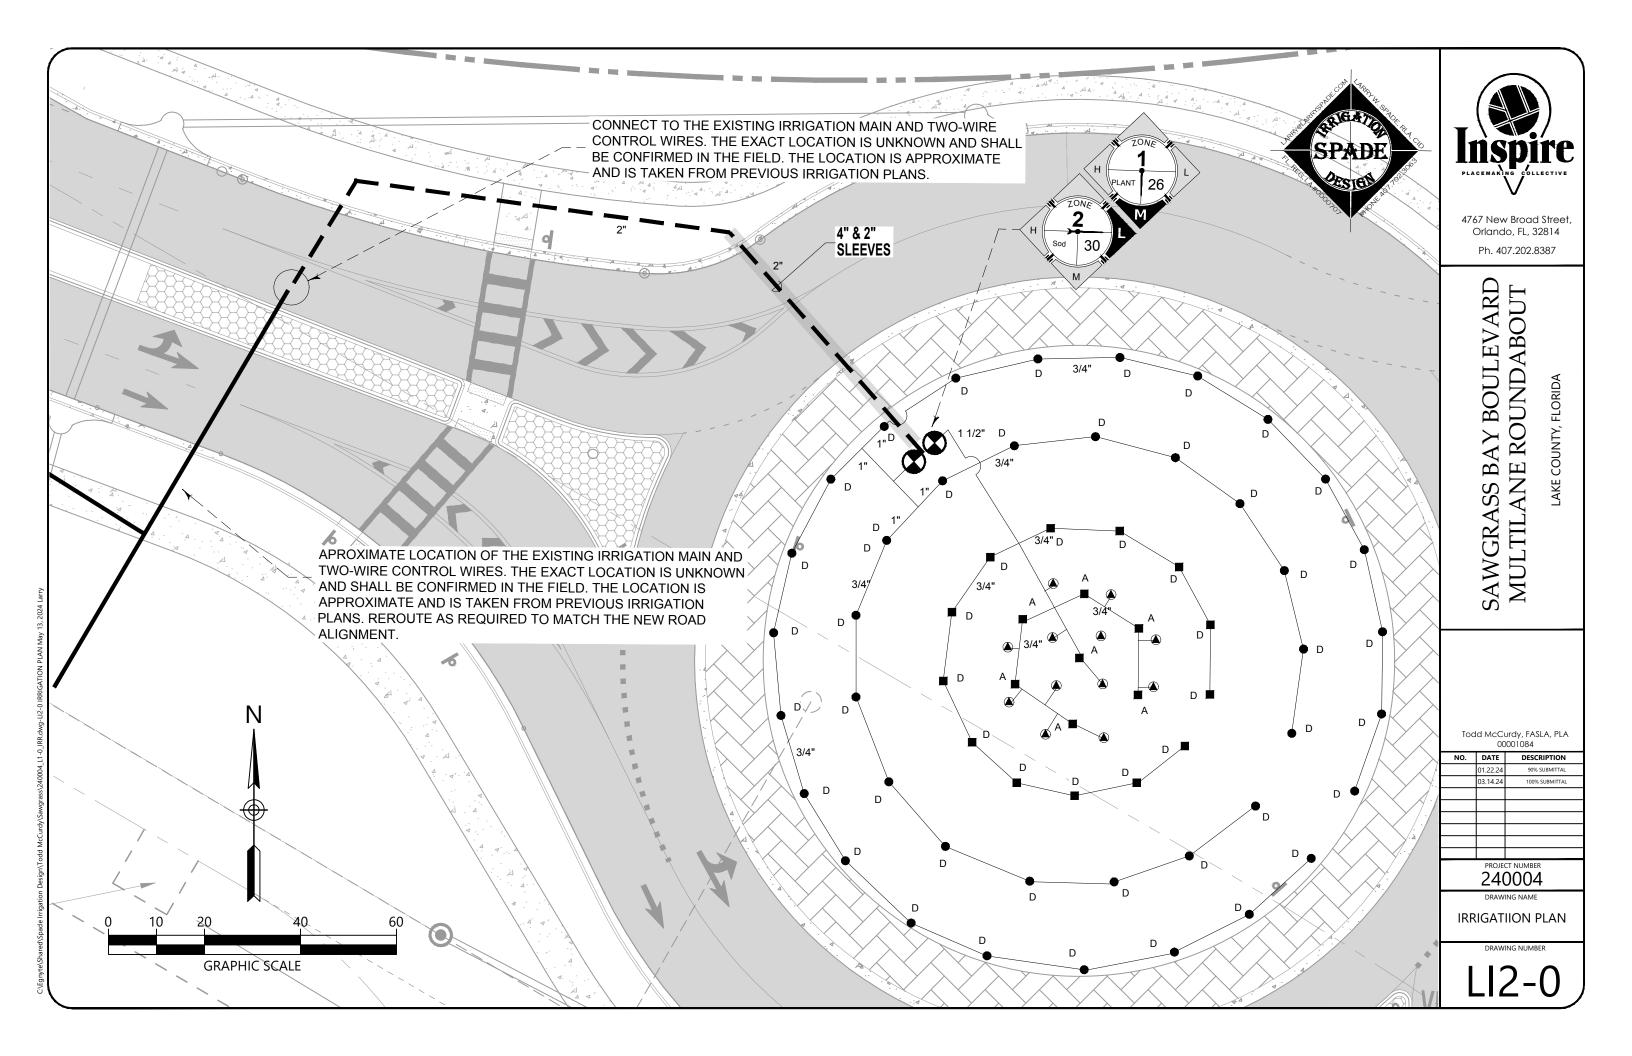
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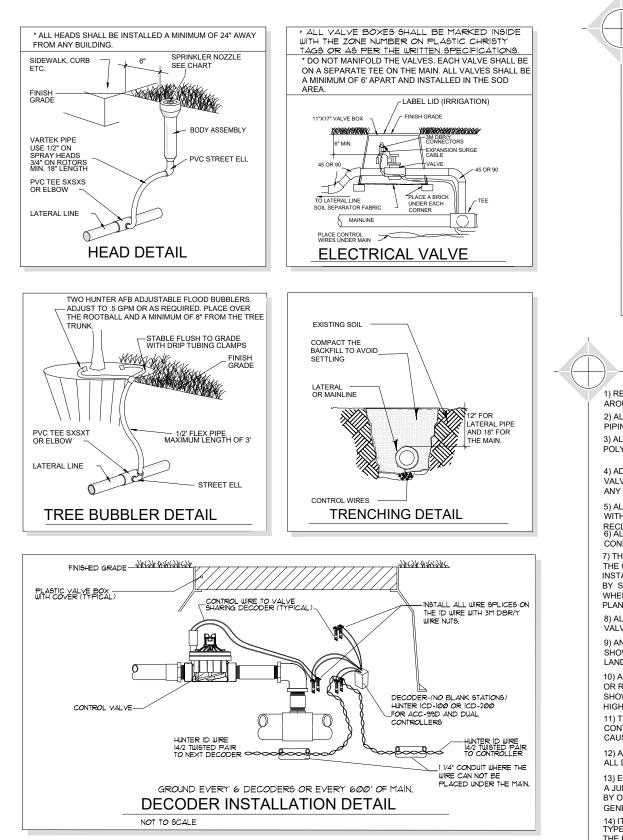
DRAWING NAME IRRIGATION

DETAILS

DRAWING NUMBER

.12-7





LEGEN	ID	REFER TO THE RECLAI USE HUNTER MP ROTA
•	HUNTER PRS40 SPRAY SERIES 6"	' POP-UP
	HUNTER PRS40 SPRAY SERIES 12	2" POP-UP
٢	TWO HUNTER AFB ADJUSTABLE F	LOOD BUBBLERS PER
	CLASS 200 PURPLE PVC MAINLIN	E-2"
	CLASS 200 PVC PURPLE LATERAL L SHOWN. MINIMUM SIZE OF 3/4" (EXC	
	SCH. 40 SLEEVE (MINIMUM OF 24" PIPE SIZE OR AS LABELED ON TH	
Ð	HUNTER ICV ELECTRIC VALVE. SI 11"X17" PURPLE VALVE BOX AND 0-25 GPM=1" 26-50 GPM=1 1/2"	

GENERAL NOTES

1) REFER TO THE LANDSCAPE PLANS WHEN TRENCHING TO AVOID TREES AND SHRUBS. HAND DIG AROUND ANY EXISTING TREES. DO NOT CUT ANY ROOTS OVER 2" IN DIAMETER.

2) ALL MAINLINE PIPING SHALL BE BURIED TO A MINIMUM DEPTH OF 18" OF COVER. ALL LATERAL PIPING SHALL BE BURIED TO A MINIMUM DEPTH OF 12" OF COVER.

3) ALL POP-UP ROTORS AND SPRAYS SHALL BE INSTALLED USING AN 18" PVC FLEX PIPE CONNECTION. DO NOT USE POLYETHYLENE PIPE. USE WELDON 737 WITH A PURPLE PRIMER OR RED HOT CHRISTY'S BLUE GLUE ON ALL CONNECTIONS.

4) ADJUST ALL NOZZLES TO REDUCE WATER WASTE ON HARD SURFACES, WINDOWS AND BLDG, WALLS, THROTTLE ALL VALVES ON SHRUB LINES AS REQUIRED TO PREVENT FOGGING. USE ADJUSTABLE NOZZLES WHERE REQUIRED TO AVOID ANY WATER ON BUILDING WINDOWS

5) ALL RISERS SHALL BE PAINTED BLACK OR A COLOR CHOSEN BY THE OWNER'S REPRESENTATIVE AND SHALL BE STAKED WITH A STEEL ANGLE AND SECURED WITH STAINLESS STEEL CLAMPS. LEAVE THE BOTTOM 12' OF THE PIPE PURPLE ON

RECLAIMED SYSTEMS. 6) ALL CONTROL WIRE CONNECTIONS SHALL BE MADE IN VALVE BOXES USING 3M DBR-Y WIRE CONNECTORS AND SEALANT WITH WIRE NUTS.

7) THE CONTRACTOR SHALL PREPARE AN AS-BUILT DRAWING SHOWING ALL IRRIGATION INSTALLATION. THE CONTRACTOR SHALL NEATLY MARK IN RED INK ON A WHITE BOND PAPER COPY OF THE IRRIGATION PLAN ANY INSTALLATION THAT DEVIATES FROM THE PLAN. THE AS-BUILT DRAWING SHALL ALSO LOCATE ALL MAINLINE AND VALVES BY SHOWING EXACT MEASUREMENTS FROM HARD SURFACES. MEASUREMENTS SHALL BE MARKED ON THE PLAN EVEN WHEN THE EQUIPMENT IS INSTALLED IN THE EXACT LOCATION AS THE PLAN. PROVIDE THE OWNER A PDF OF THE AS-BUILT PI AN

8) ALL VALVES, GATE VALVES AND QUICK COUPLERS SHALL BE INSTALLED IN VALVE BOXES. THE VALVE BOXES SHALL BE PURPLE WHEN USING RECLAIMED WATER.

9) ANY PIPING SHOWN OUTSIDE THE PROPERTY LINE OR RUNNING OUTSIDE A LANDSCAPE AREA IS SHOWN THERE FOR CLARITY ONLY. ALL LINES SHALL BE INSTALLED ON THE PROPERTY AND INSIDE THE LANDSCAPE AREAS OR INSIDE A SCH. 40 SLEEVE.

10) ALL HEADS SHALL BE INSTALLED A MINIMUM OF 24" FROM ANY WALL AND A MINIMUM OF 6" FROM ANY SIDEWALK, PATIO OR ROAD. (MINIMUM OF 2'-0" WHERE THERE ARE NO BUMPER STOPS) THE EXACT HEIGHT OF ANY 12" POP-UP THAT IS SHOWN IN A SHRUB BED SHALL BE DETERMINED BY THE OWNER'S REPRESENTATIVE IN THE FIELD. INSTALL THE 12" POP-UP HIGHER WHERE BLOCKED BY TALL SHRUBS.

11) THE CONTRACTOR SHALL EXERCISE CARE SO AS NOT TO DAMAGE ANY EXISTING UTILITIES. THE CONTRACTOR SHALL BE RESPONSIBLE FOR THE IMMEDIATE REPAIRS AND COST OF ANY DAMAGE CAUSED BY THEIR WORK

12) ALL WORK SHALL BE GUARANTEED FOR ONE YEAR FROM THE DATE OF FINAL ACCEPTANCE AGAINST ALL DEFECTS IN EQUIPMENT AND WORKMANSHIP OR AS OUTLINED IN THE WRITTEN SPECIFICATIONS.

13) ELECTRICAL SERVICE TO LOCATION OF THE CONTROLLER, WELL OR PUMP SHALL BE PROVIDED TO A JUNCTION BOX OR DISCONNECT AT THE EQUIPMENT LOCATION BY THE ELECTRICAL CONTRACTOR OR BY OWNER WHEN IT IS NOT PART OF THE BID PACKAGE. CONFIRM THE LOCATION OF THE CONTROLLER WITH THE OWNER OR GENERAL CONTRACTOR BEFORE ANY INSTALLATION.

14) IT SHALL BE THE RESPONSIBILITY OF THE CONTRACTOR TO SCALE THE PLAN AND CHECK NOZZLE TYPES TO DETERMINE THE CORRECT SPACING OF THE HEADS. THE CONTRACTOR SHALL NOT SPACE THE HEADS FURTHER APART OR USE LESS HEADS THAN SHOWN ON THE PLAN. ANY CHANGES TO THE HEAD SPACING OR LAYOUT, WITHOUT THE CONSENT OF THE LANDSCAPE ARCHITECT OR OWNER, SHALL HOLD THE IRRIGATION CONTRACTOR RESPONSIBLE FOR WARRANTY OF THE PLANTS AND OR SOD IN THESE AREAS

15) 48 HOURS BEFORE DIGGING, CALL 1-800-432-4770 (SUNSHINE STATE ONE CALL CENTER) 16) INSTALL THREE EXTRA CONTROL WIRES TO EACH TERMINATION OF THE MAIN. ALL CONTROL WIRES SHALL BE INSTALLED INSIDE OF SCH. 40 GRAY PVC CONDUIT WHERE THEY CANNOT BE UNDER THE MAIN.

CLAIMED WATER NOTES OTATOR NOZZLES	
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UNTIL A SMALLER SIZE IS EX PIPE)	
S LARGER THAN THE	
DW. INSTALL VALVE IN A	





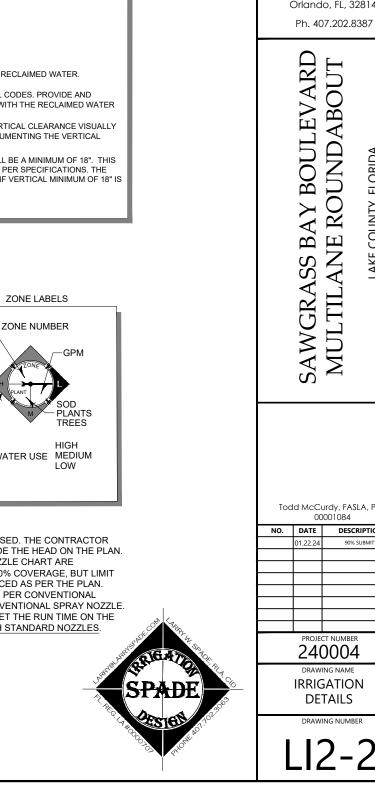
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Α	MP2000	RED	1.47	19'	FULL	360°	
В	MP CORNER	TURQUOISE	.45	14'	CORNER	105°	Z
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THE NOZZLES LISTED SHOW THE TYPE OF MP ROTATOR NOZZLE THAT SHOULD BE USED. THE CONTRACTOR SHOULD INSTALL CORRECT NOZZLE IN EACH HEAD AS SHOWN BY THE LETTER BESIDE THE HEAD ON THE PLAN. DO NOT USE MP1000 SERIES NOZZLES. THE GPM, DISTANCE AND ANGLE ON THE NOZZLE CHART ARE APPROXIMATE. THE CONTRACTOR SHALL ADJUST ALL NOZZLES TO PROVIDE THE 100% COVERAGE, BUT LIMIT OVERTHROW ON TO BUILDINGS, WALLS, PAVEMENT, ETC, THE HEADS SHALL BE SPACED AS PER THE PLAN. SCALE THE PLAN FOR DISTANCE. DO NOT ASSUME THAT ALL HEADS ARE SPACED AS PER CONVENTIONAL SPRAY HEADS. THE PRECIPITATION RATE FOR THESE NOZZLES IS LESS THAN A CONVENTIONAL SPRAY NOZZLE. FOLLOW THE ZONE CHART FOR AN APPROXIMATE RUN TIME FOR EACH ZONE, BUT SET THE RUN TIME ON THE CONTROLLER BASED ON THE SPECIFIC SITE CONDITIONS. DO NOT SUBSTITUTE WITH STANDARD NOZZLES.





4767 New Broad Street, Orlando, FL, 32814

> MULTILANE ROUNDABOUT FLORIDA COUNTY, LAKE

Todd McCurdy, FASLA, PLA 00001084



240004

DRAWING NAME IRRIGATION

DRAWING NUMBER

		E		ACCE	=NI	LUMINAIRE KEY	CHARACTER TYPE
BOLLARD	IORMAL EMERGENCY	NO LIGHT SOURCE	NORMAL D +		SURFACE		B BOLLARD / SHORT BASE C CLOSE CEILING F FAN G GAS FLAME FOR LUMINAIRE
RECESSED	⊶⊡ ⊶∎	SINGLE HEAD	۰⊕•	+ @ +	WALL		L LAMPPOST M MULTLAMP / FESTOON P PENDANT R RECEPTACLE FOR LUMINAIRE S SURFACE
SURFACE	┅□	MULTIPLE HEAD	- D +	•	TRACK		T TABLE LAMP W WALL MOUNTED
R	LINE/	R		POWE	R	LUMINAIRE TAG	LUMINAIRE TYPE
,	IORMAL EMERGENCY		NORMAL	EMERGENCY			A ACCENT / AIMABLE
SURFACE -		ADJUSTABLE	899] (1997)	PS	POWER SUPPLY	$CP2 \left[\frac{1001}{4}\right]$	B BOLLARD / PATH/STEP C CHARACTER D DOWNLIGHT
PENDANT +		SET	데찍	PD	POWER / DATA		E SPECIALTY / THEATRICAL F FLOODLIGHT / SPOTLIGHT G INGRADE
WALL -		MULTILAMP	Ø		POWER SOURCE	CHARACTER TYPE	H HIGH BAY / HAZARDOUS I INDIRECT J JUNCTION BOX
BASE W/ HEAD		SLOT	٥		JUNCTION BOX	LUMINAIRE TYPE	K C(K)LEAN/GASKETED L LUNEAR M MULTILAMP / STRING LIGHTS N NICHE / COVE 0 [NOT USED]
	UNDERW	ATER		GENEF	RAL	CONTROL TAG	P POLE / PAŘKING Q POWER SUPPLIES R TROFFER S SURFACE / STRIPLIGHT T TRACK U UNDERWATER
,	IORMAL EMERGENCY		NORMAL	EMERGENCY		<742>(DMX)	V VANDAL W WORKLIGHT / WALLPACK
IN-GRADE		UNDERWATER	•	•	PENDANT		X EXIT / EMERGENCY Y GRAPHIC Z [USED IN ZONING]
DIRECTIONAL	-(11111	SURFACE	ю	H	WALL	DMX CONTROLLED ZONE CONTROL NUMBER ZONE INDICATOR	
	BOLLARD RECESSED SURFACE R SURFACE PENDANT WALL BASE W/ HEAD	BOLLARD	BOLLARD ↔ NO LIGHT SOURCE RECESSED SURFACE ↔ SINGLE HEAD SURFACE ↔ MULTIPLE HEAD R SURFACE ↔ MULTIPLE HEAD NORMAL EMERGENCY HALL SASE W/ HEAD NORMAL EMERGENCY NORMAL EMERGENCY NORMAL EMERGENCY INORMAL EMERGENCY	BOLLARD <	BOLLARD <l< td=""><td>BOLLARD</td><td>SREARD</td></l<>	BOLLARD	SREARD

									LUMINAIRE	SCHEDULE												
REV					FIXTURE								LIGHT SC	URCE				VOLTAGE	FIXTURE	CONTROL GE AR	ACCESSORIES	NOTES
Δ	ТҮРЕ	MANUFACTURER	REPRESENTATIVE	PART NO	DESCRIPTION	DIME N SION S	UL/IP	FIN ISH	MATE RIAL	MOUNTING	MANUFACTURER	PARTNO	QTY OF	TIC CO	T CRI	LUMENS	WATT	VOLTAGE	LOAD	CONTROL GLAR	ACCESSORIES	NOTES
A: ACCEN	T; AIMABI	LE																				
	A1	GARD EN LIGHT LED	IAL // THOMAS WUNDERLICH 689.220.8303	VISION3-3000K-9W -FIN TBD; STAKE:LV150	LAND SC APE UP LIGHT - ME DIUM BE AM	2.25"DIA x 5.8"L	ETL; IP66	TBD		STAKE	INTEGRAL	WHITE LED	1 25	DEG 300	ж <mark>80</mark>	660	9 W	12 VAC	15.0	REMOTE TRANSFORMER 'PSU1'		
P: POLE;	PARKING																		* 			
	P1	RECOVERED ENEREGY TECHNOLOGIES	-	HEAD: CORLIGHT LS35 (UP 4-H-NR) POLE: ALLIANCE COMPOSITE #DX26AXDN3X6	SINGLE HEADED ROAD WAY POLE WITH INTEGRAL SOLAR PANELS	TBD	UL	MATCH EXISTING	ALUMINUM/ COMPOSITE	DIRECT BURIAL	INTEGRAL	WHITE LED	1 MA	ГСН МАТ	CH 70	6400	MATCH	MATCH		SOLAR		1
Q: POWE	R SUPPLI	IE S															~					
	P SU1	GARD EN LIGHT LED	IAL // THOMAS WUNDERLICH 689.220.8303	102WLED-SS	SURFACE MOUNT REMOTE TRANSFORMER FOR LANDSCAPE ACCENTS - 100W	4.25"D x 5" W x 11"H	UL NEMA5-15	-	STAINLESS STEEL	SURFACE	-	-	÷		-	-	100W	120/12VAC	100.0	NON-D M		

NOTE S: 1. SUBMIT SHOP DRAWINGS WITH STATE OF FLORID AREGISTERED ENGINEER'S CALCULATIONS TO MEET FBC WIND LOAD REQUIREMENTS (LATEST STANDARDS) FOR POLE ASSEMBLY INCLUDING DIMENSIONS AND POLE/FIXTURE EPA RATINGS.

GENERAL NOTES

FORMATION PROVIDED ON THE LEGEND SHEET MAY NOT BE IMPLEMENTED INTO ROJECT.

DRAWINGS ARE FOR INFORMATION ONLY, REFER TO THE ELECTRICAL DRAWING IRCUIT INFORMATION.

R TO FIXTURE SPECIFICATIONS FOR COMPLETE FIXTURE INFORMATION.

R TO FIXTURE MOUNTING DETAIL SHEETS FOR SPECIFIC MOUNTING CONDITIONS. RACTOR TO PROVIDE TRANSFORMERS AND BALLASTS FOR ALL FIXTURES FIED AS REMOTE TRANSFORMERS OR BALLAST. ALL TRANSFORMERS AND IST SPECIFIED AS REMOTE SHALL BE MOUNTED OUT OF VIEW OF GUESTS.

RACTOR TO CONFIRM ALL REMOTE TRANSFORMER AND BALLAST LOCATIONS WITH SCAPE OR FACILITY ARCHITECT.

ACTOR TO VERIFY EXACT MOUNTING LOCATION OF ALL ACCENT LIGHTS IN WITH LIGHTING DESIGNER.

SS OTHERWISE INDICATED, ALL MOUNTING BOXES FOR LIGHTING FIXTURES TED TO FACADES TO BE RECESSED INTO STRUCTURE. COORDINATE JBOX TION WITH OTHER TRADES.

W CONSTRUCTION MANAGER IN WRITING IN A TIMELY WAY OF ANY EPANCIES DISCOVERED.

RACTOR TO VERIFY CONDITIONS ON WHICH THIS WORK DEPENDS IN OTHER D CONSTRUCTION DRAWINGS AND ON SITE SUCH AS BUT NOT LIMITED TO: MENSIONS VELS ATERIALS TARIALS

DEMOLITION

EXISTING TO BE REMOVED

EXISTING TO BE RELOCATED

EXISTING TO REMAIN

EXISTING - NEW LOCATION



4767 New Broad Street, Orlando, FL, 32814

Ph. 407.202.8387

exp U.S. Services Inc. I: +1.407.660.0088 | f. +1.407.660.1655 2601 Westhall Lane Maittland, FL 32751 U.S.A.

SAWGRASS BAY BOULEVARD MULTILANE ROUNDABOUT

COUNTY, FLORIDA

LAKE (

www.exp.com USS-24024024-00 Cert of Auth: 29701



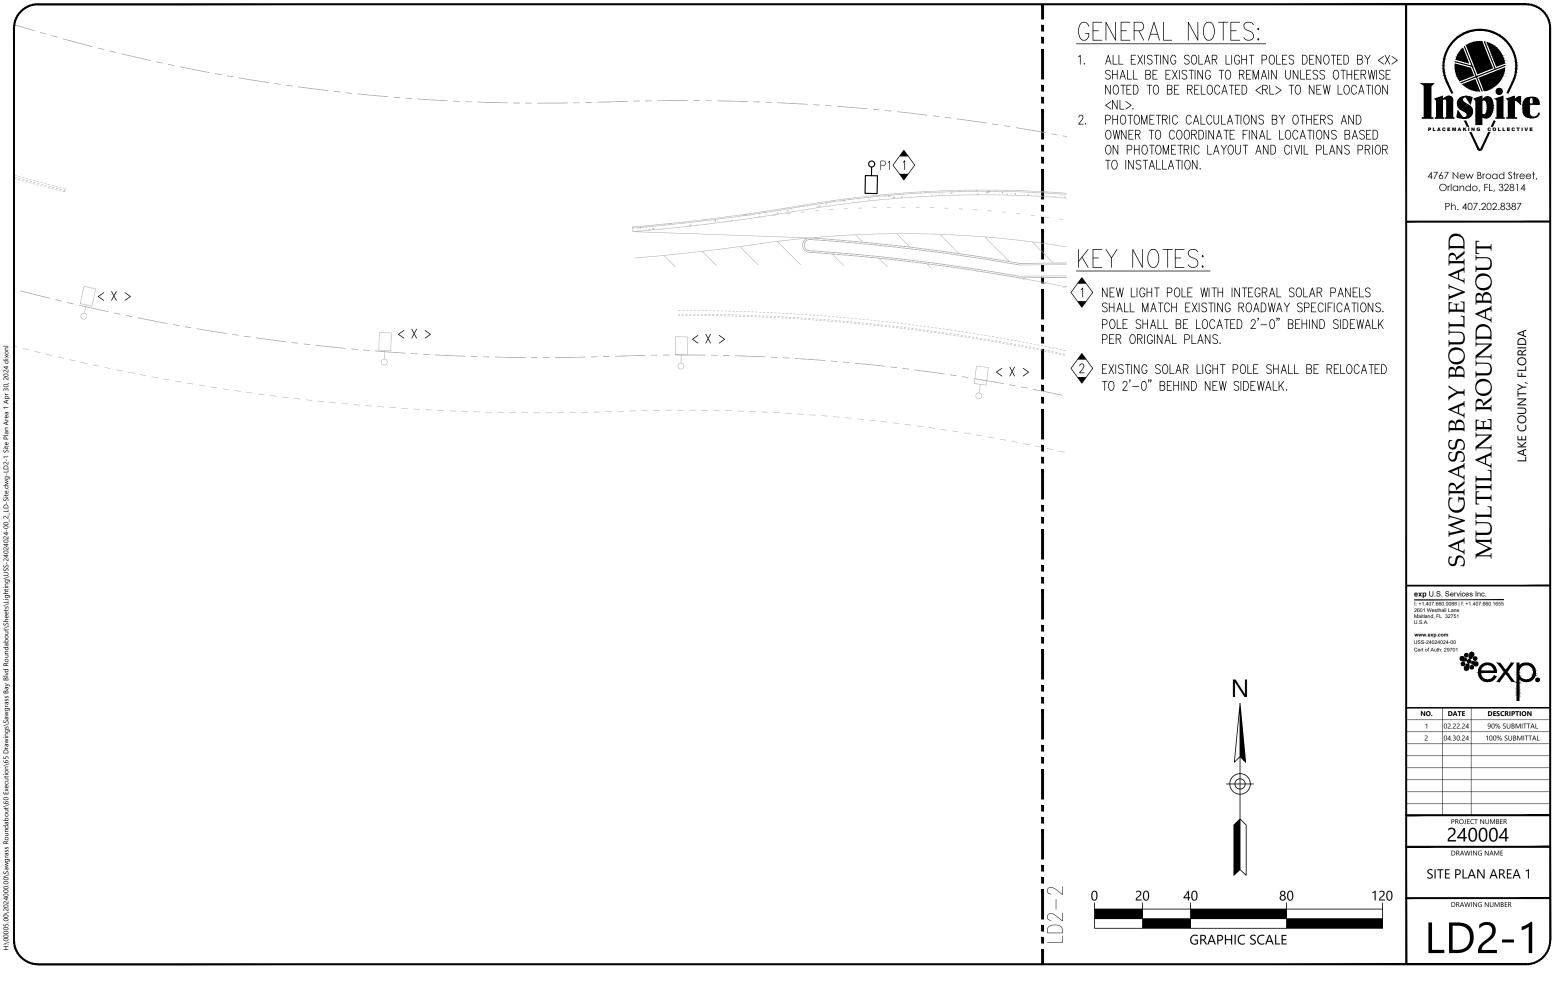
NO.	DATE	DESCRIPTION
1	02.22.24	90% SUBMITTAL
2	04.30.24	100% SUBMITTAL

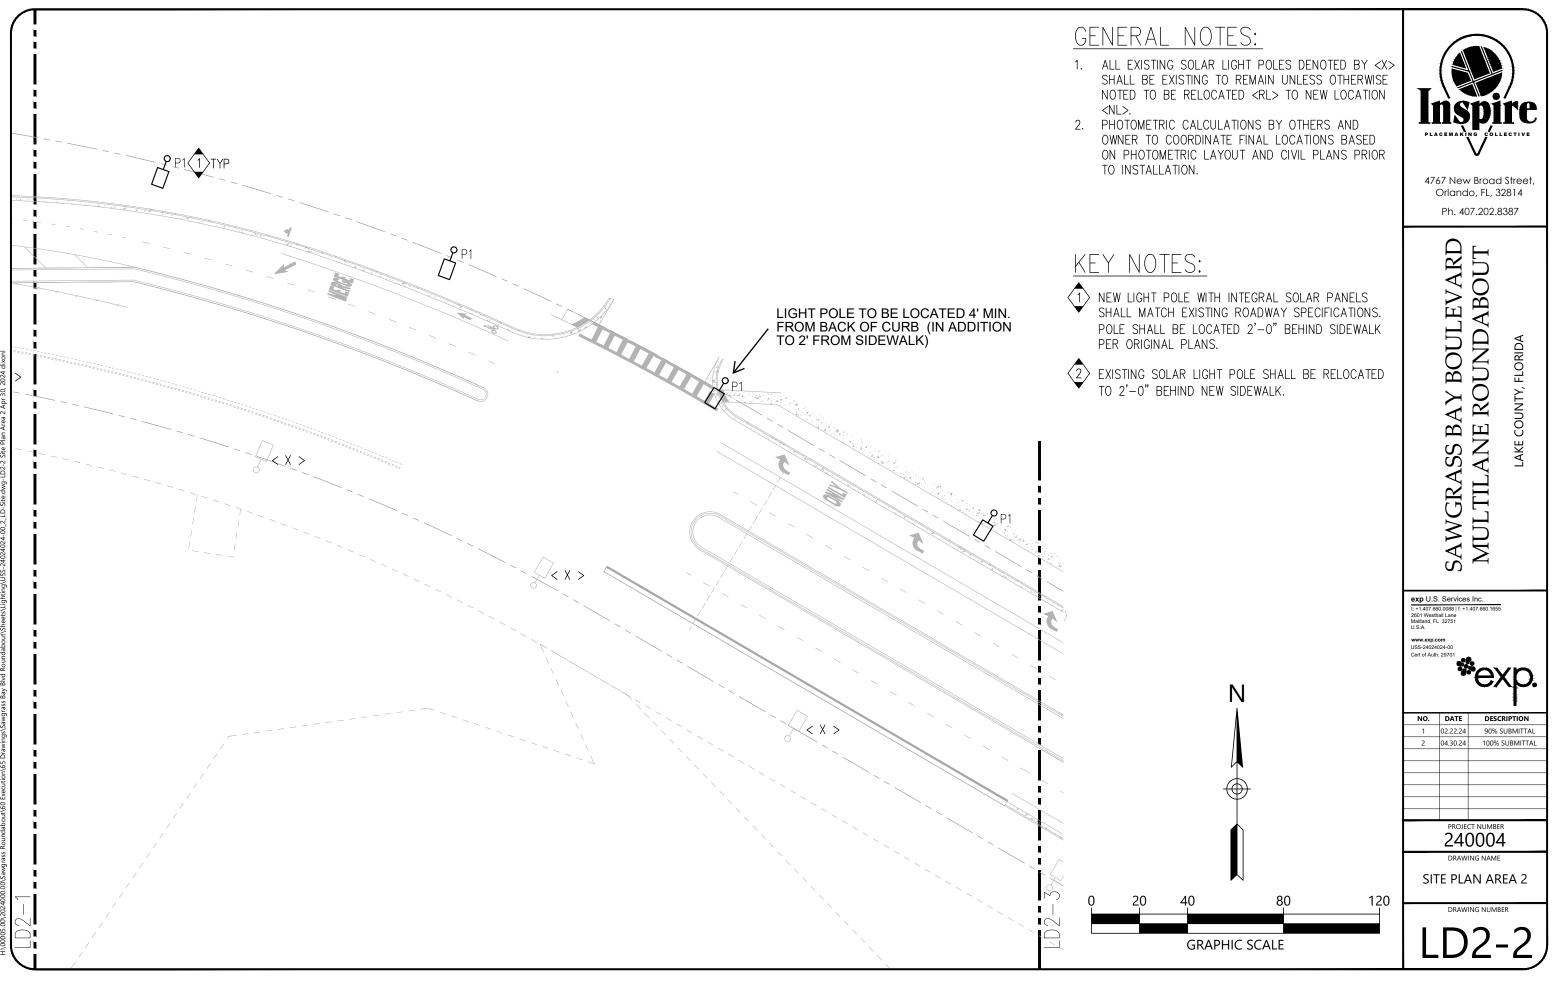
PROJECT NUMBER 240004 DRAWING NAME

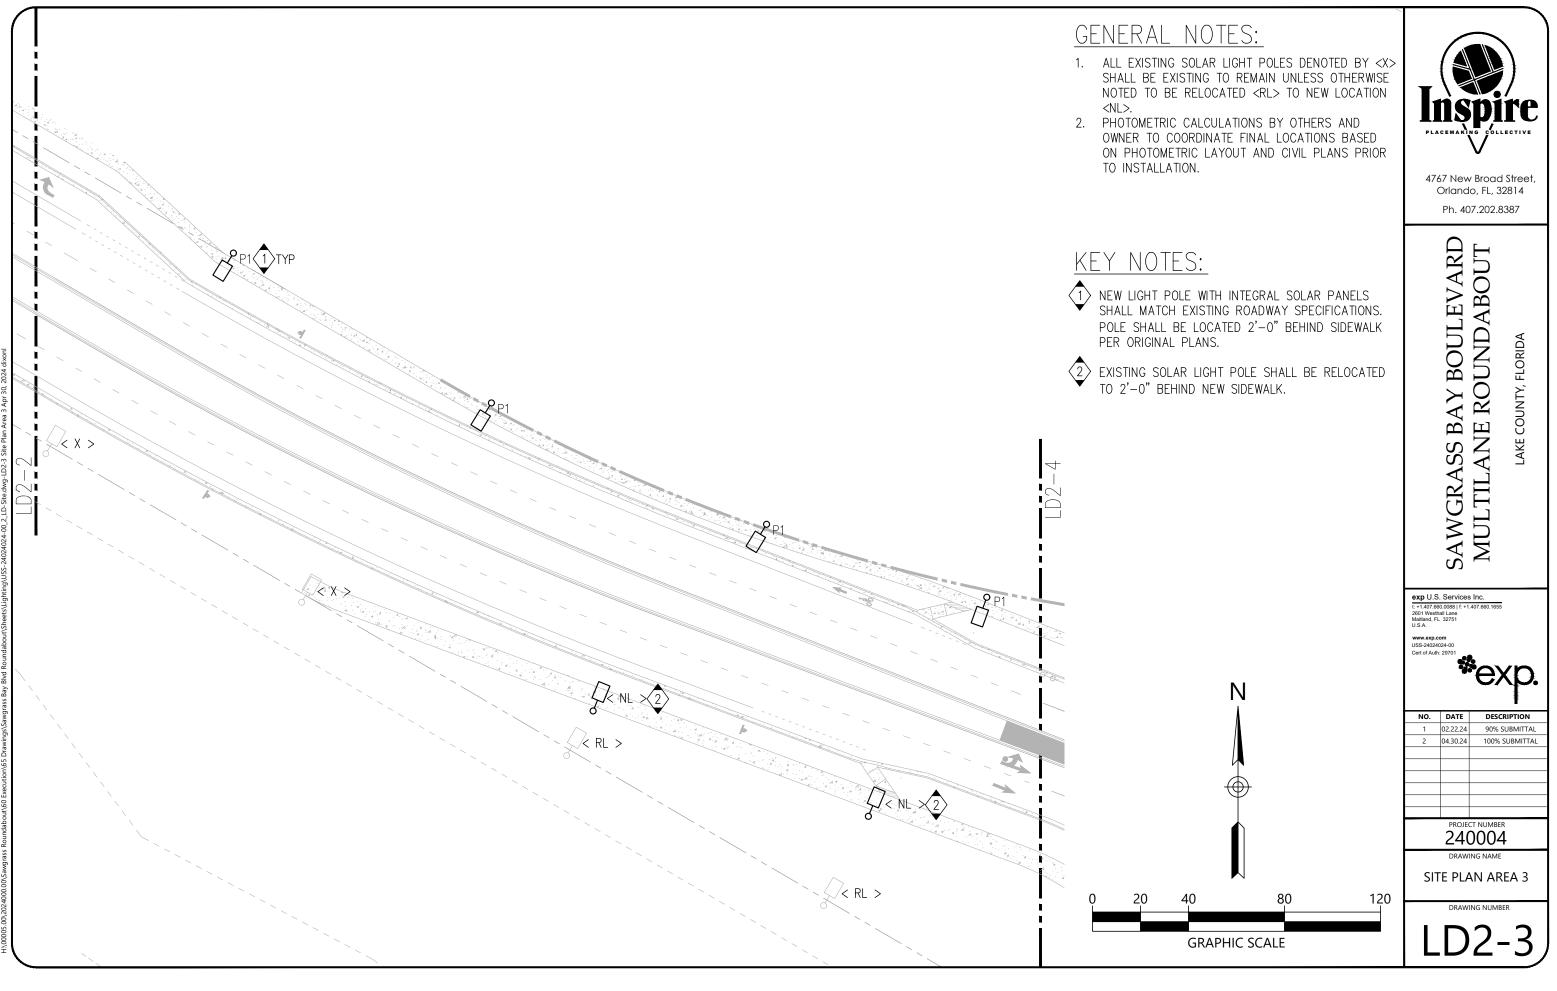
LEGEND & SCHEDULE

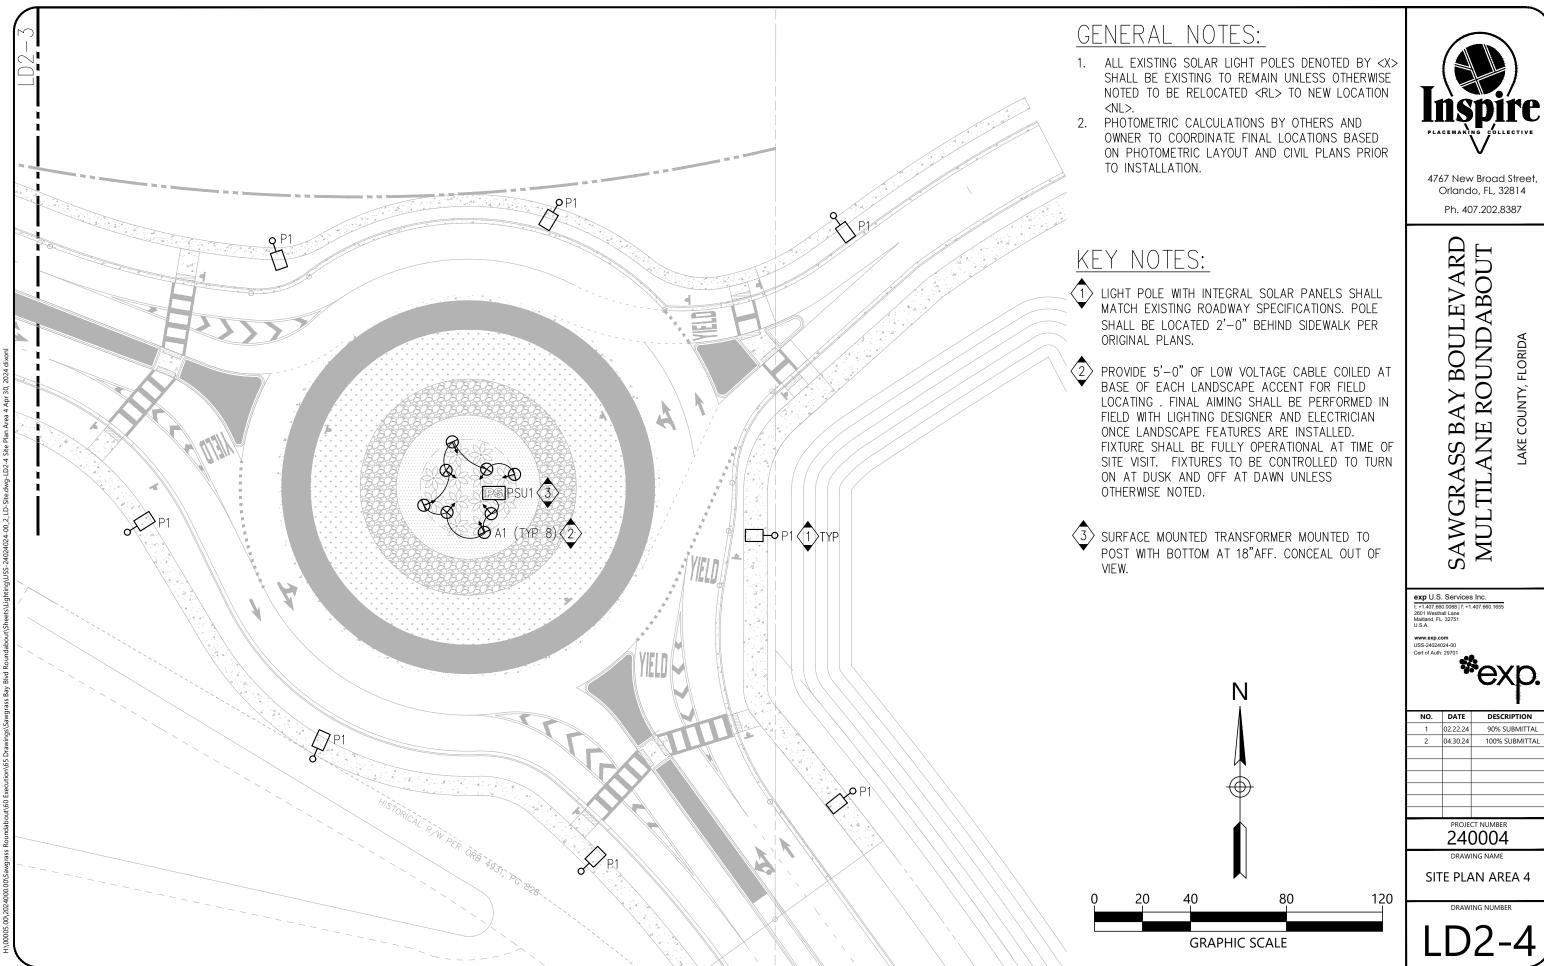
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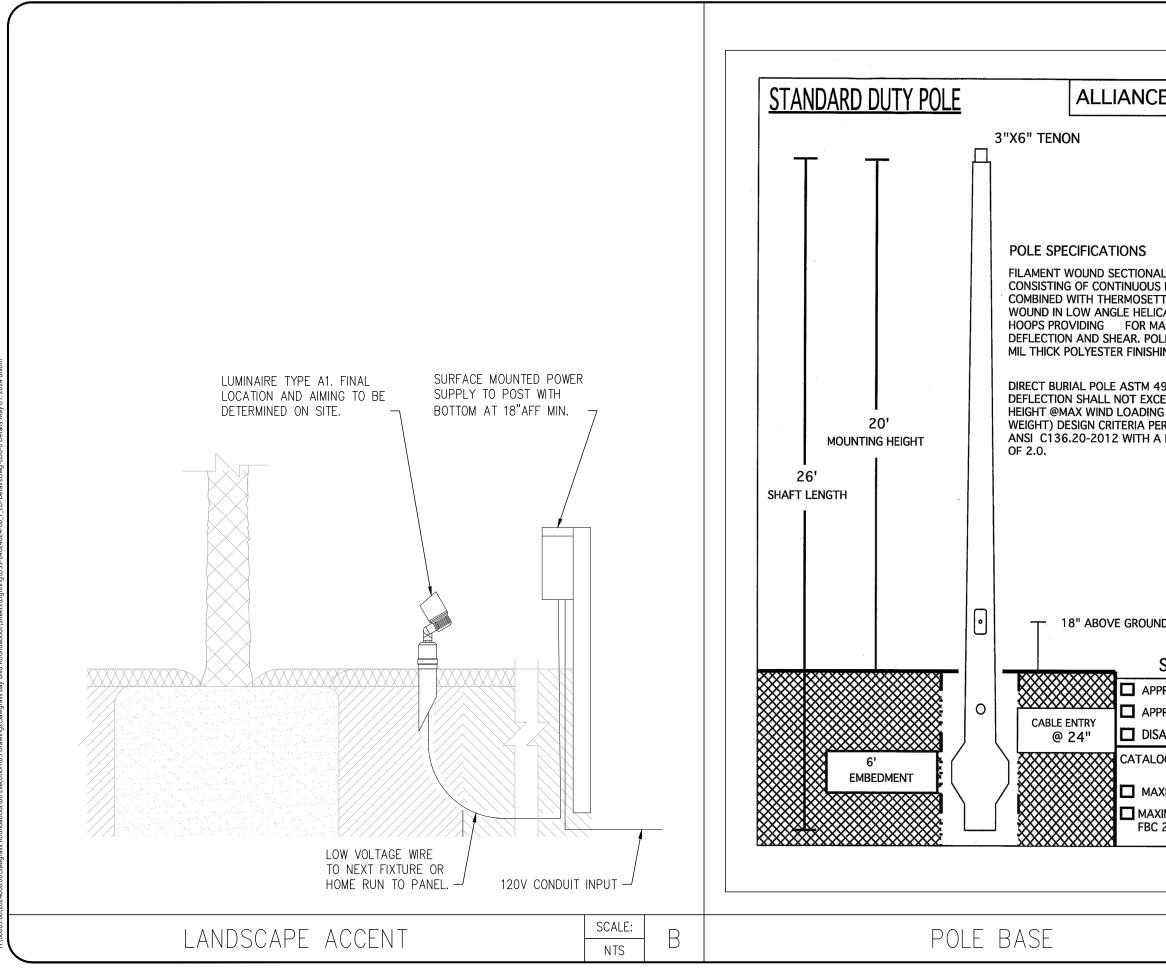
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E COMPOSITES			Inspire
n an			PLACEMAKING COLLECTIVE
			4767 New Broad Street, Orlando, FL, 32814
			Ph. 407.202.8387
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L COMPOSITE SHAFT			SAWGRASS BAY BOULEVARI MULTILANE ROUNDABOUT Lake county, florida
TING POLYESTER RESIN CALS AND HIGH ANGLE			AB
AXIMUM RESISTANCE TO LE FINISH IS A 10 TO 15			D/D
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			t: +1.407.660.0088 f: +1.407.660.1655 2601 Westhall Lane Maitland, FL 32751 U.S.A.
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APROVED			1 02.22.24 90% SUBMITTAL 2 04.30.24 100% SUBMITTAL
DG NUMBER : DX26AXDN	3X6		
XIMUM FIXTURE EPA = 10			
(IMUM WIND VELOCITY = 1	80 MPH		PROJECT NUMBER
2017			240004
			DETAILS
			DRAWING NUMBER
	SCALE:	Δ	LD6-0
	NTS		