


PRELIMINARY PLAT OF SPRINGS AT CHERRY LAKE


A Single-Family Residential Subdivision

LEGAL DESCRIPTION (PROVIDED BY LAND SURVEYOR)	
<p>A parcel of land lying in and being a portion of Government Lot 5, Section 3, Township 22 South, Range 25 East, Lake County, Florida, being more particularly described as follows:</p> <p>Commence at the Northeast corner of said Government Lot 5, thence coincident with the North Boundary of said Government Lot 5, N 89°38'51" W a distance of 99.33 feet to a point on the South Right-of-way Boundary of Cherry Lake Road; said point being the POINT OF BEGINNING, said point also being on a non-tangent curve concave to the Southwest, said curve having a radius of 44.74 feet, a delta angle of 72°35'14", and being subtended by a chord bearing S 35°43'27" E for 0.00' feet; thence 0.07 feet to a point on the West boundary of said Government Lot 5, thence a point on the Westerly Right-of-way Boundary of Cherry Lake Road; thence coincident with said Westerly Right-of-way Boundary for the following two (2) calls; 1) S 00°34'06" W a distance of 1116.72 feet to a point on a curve concave to the Northeast, said curve having a radius of 243.63 feet, a delta angle of 44°40'27" and being subtended by a chord bearing S 21°43'46" E for a distance of 185.18 feet; 2) thence Southerly coincident with the arc of said curve 189.96 feet to a point on the East Boundary of said Government Lot 5; thence departing said Westerly Right-of-way Boundary coincident with said East Boundary, S 00°29'21" W a distance of 472.13 feet; thence departing said East Boundary, S 39°28'15" W a distance of 368.35 feet to a point on a curve concave to the South, said curve having a radius of 50.50 feet, a delta angle of 105°09'17" and being subtended by a chord bearing S 27°30'18" W for a distance of 15.39 feet; thence coincident with the arc of said curve 91.71 feet to a point of reverse curvature with a curve concave to the North, said curve having a radius of 25.00 feet, a delta angle of 70°31'44" and being subtended by a chord bearing S 55°13'31" W for a distance of 28.87 feet; thence coincident with the arc of said curve 30.77 feet; thence N 89°30'37" W a distance of 157.21 feet to a point on a tangent curve concave to the South, said curve having a radius of \$25.00 feet, a delta angle of 8°10'32" and being subtended by a chord bearing S 86°24'07" W for a distance of 74.85 feet; thence coincident with the arc of said curve 74.91 feet; thence S 82°18'51" W a distance of 180.47 feet to a point on a tangent curve concave to the North, said curve having a radius of 208.42 feet, a delta angle of 31°54'21" and being subtended by a chord bearing N 87°55'35" W for a distance of 114.57 feet; thence coincident with the arc of said curve 116.06 feet to a point on a tangent curve concave to the South, said curve having a radius of 100.00 feet, a delta angle of 207.95 feet, a delta angle of 13°57'25" and being subtended by a chord bearing N 62°49'45" W for a distance of 50.53 feet; thence coincident with the arc of said curve 50.66 feet; thence N 58°37'16" W a distance of 80.91 feet; thence N 31°22'51" E a distance of 104.00 feet; thence N 31°22'44" E a distance of 196.80 feet; thence N 18°44'06" E a distance of 316.45 feet; thence N 04°42'25" E a distance of 123.51 feet; thence N 03°09'47" W a distance of 170.00 feet; thence N 04°49'22" W a distance of 32.83 feet; thence S 87°33'56" W a distance of 140.22 feet to a point on a non-tangent curve concave to the West, said curve having a radius of 1428.62 feet, a delta angle of 9°38'28" and being subtended by a chord bearing N 07°15'40" W for a distance of 240.11 feet; thence coincident with the arc of said curve 240.39 feet; thence N 11°45'00" W a distance of 387.44 feet to a point on a tangent curve concave to the East, said curve having a radius of 270.00 feet, a delta angle of 6°32'20" and being subtended by a chord bearing N 19°58'41" E for a distance of 283.98 feet; thence coincident with the arc of said curve 299.03 feet; thence N 51°42'20" E a distance of 70.58 feet to a point on a curve concave to the Northeast, said curve having a radius of 200.00 feet, a delta angle of 10°00'00" and being subtended by a chord bearing N 42°20'52" E for a distance of 97.56 feet; thence coincident with the arc of said curve 98.00 feet to a point of reverse curvature with a curve concave to the Southeast, said curve having a radius of 787.00 feet, a central angle of 6°16'08" and being subtended by a chord bearing N 36°07'28" E for a distance of 86.07 feet; thence coincident with the arc of said curve 86.11 feet to a point of reverse curvature with a curve concave Northwesternly, said curve having a radius of 93.00 feet, a central angle of 30°37'32" and being subtended by a chord bearing N 23°56'46" E for a distance of 49.12 feet; thence coincident with the arc of said curve 49.71 to a point of compound curvature concave to the West, said curve having a radius of 326.00 feet, a central angle of 8°16'52" and being subtended by a chord bearing N 04°29'35" E for a distance of 47.08 feet; thence coincident with the arc of said curve 47.12 feet; thence N 00°23'16" E a distance of 12.57 feet to a point on a curve concave Southeastery, said curve having a radius of 25.00 feet, a central angle of 90°00'00" and being subtended by a chord bearing N 45°21'09" E for a distance of 35.36 feet; thence coincident with the arc of said curve 39.27 feet; thence N 00°00'00" a distance of 15.00 feet to a point on the Southerly Right-of-way Boundary of Cherry Lake Road; thence coincident with said Southerly Right-of-way Boundary S 89°38'51" E a distance of 563.84 feet to the POINT OF BEGINNING.</p> <p>Containing an area of 1660394.10 square feet, 38.117 acres more or less.</p>	

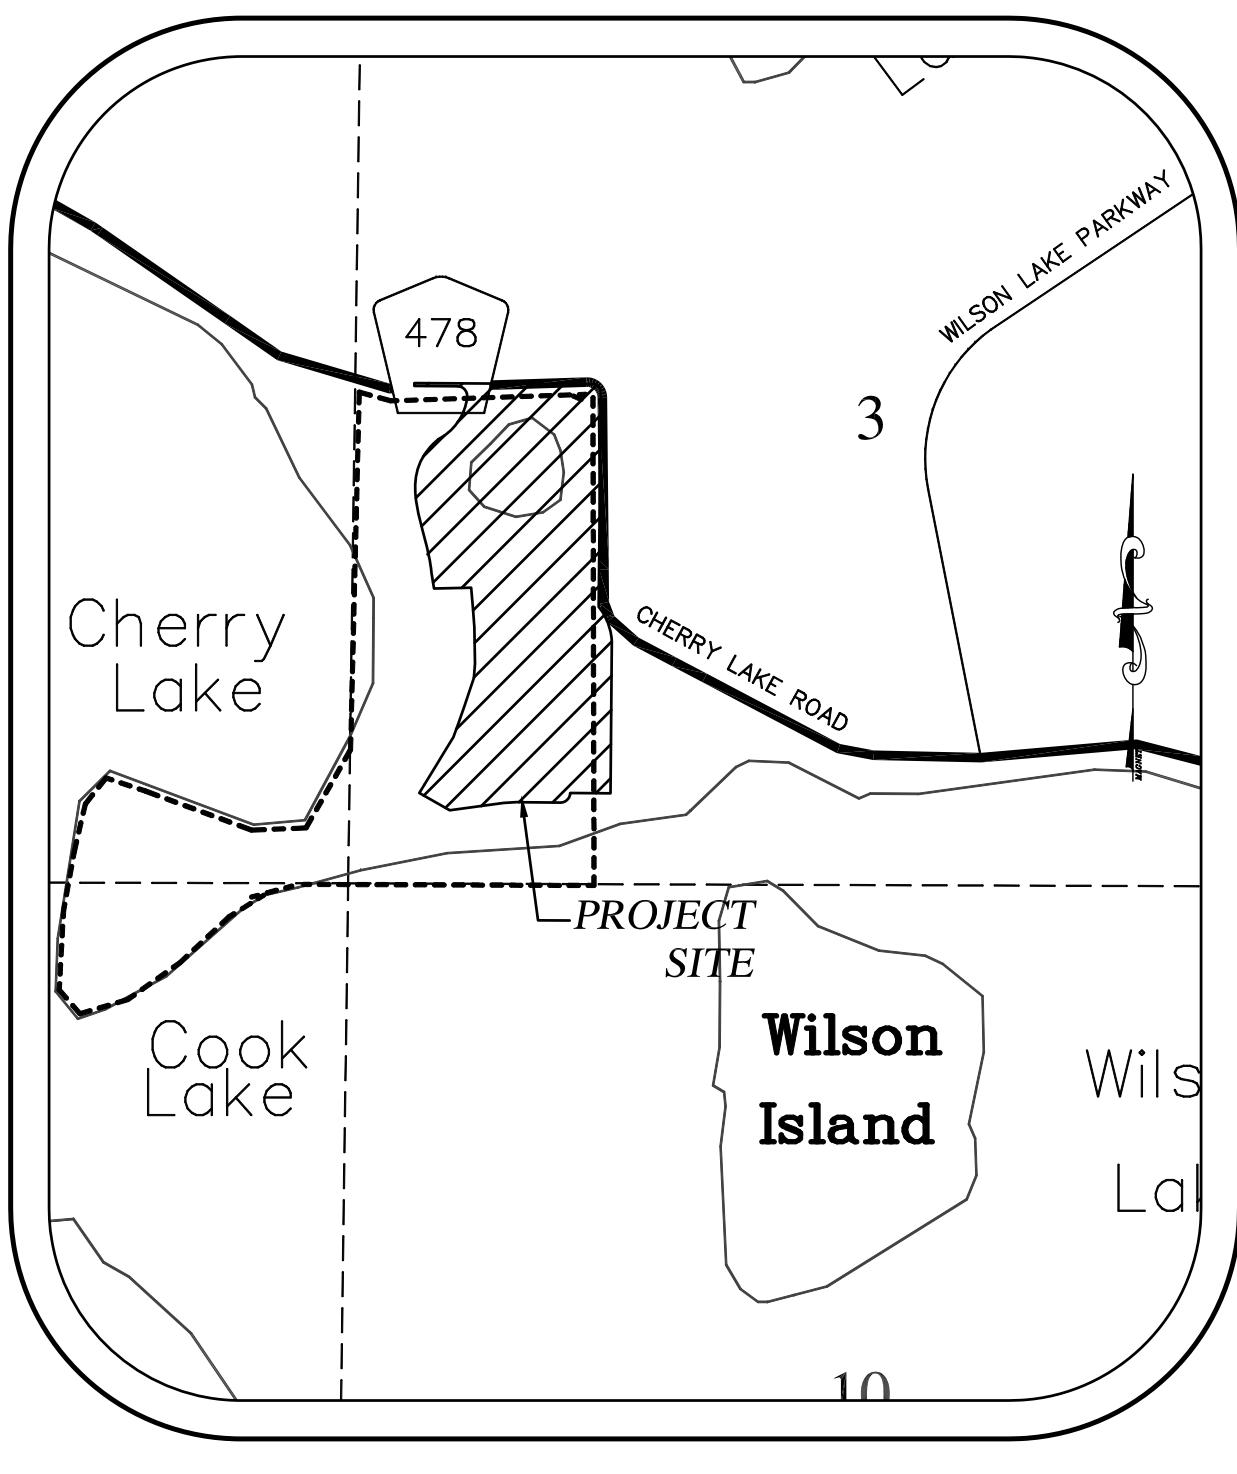

SECTION 3, TOWNSHIP 22S, RANGE 25E
CITY OF GROVELAND, FLORIDA

SERVICES	
POTABLE WATER.....	CITY OF GROVELAND
SANITARY SEWER.....	CITY OF GROVELAND
ELECTRIC.....	DUKE ENERGY
TELEPHONE.....	EMBARQ
CABLE TELEVISION.....	COMCAST
FIRE PROTECTION.....	CITY OF GROVELAND
POLICE PROTECTION.....	CITY OF GROVELAND
SCHOOLS.....	LAKE COUNTY PUBLIC SCHOOLS

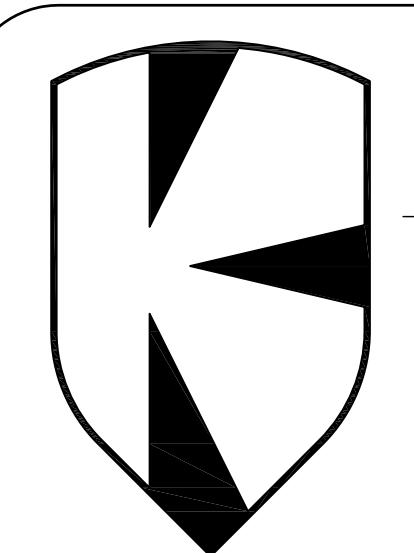

**THOMAS L. KNIGHT, P.E.
PROFESSIONAL ASSOCIATION**
Planning, Design, Permitting, Inspection
1135 EAST AVENUE, CLERMONT, FL 34711
PHONE: (352) 394-8514

Certificate of Authorization No. 00029972

PROJECT NO.
K06-11

OWNER/DEVELOPER
L&D LLC, ET AL P.O. BOX 97 BELL, FL 32619 (352) 463-2942

LAND SURVEYOR
SURVTECH SOLUTIONS, INC. 10220 U.S. HWY 92 E. TAMPA, FL 33610 (813) 621-4929

GEOTECHNICAL ENGINEER
ANDREYEV ENGINEERING, INC. 1170 W. MINNEOLA AVENUE CLERMONT, FL 34711 (352) 241-0508

LANDSCAPE CONSULTANT
TILLMAN AND ASSOCIATES ENGINEERING, LLC 1720 SE 16TH AVENUE, BLDG. 100 OCALA, FLORIDA 34471 (352) 307-1947

SHEET INDEX	
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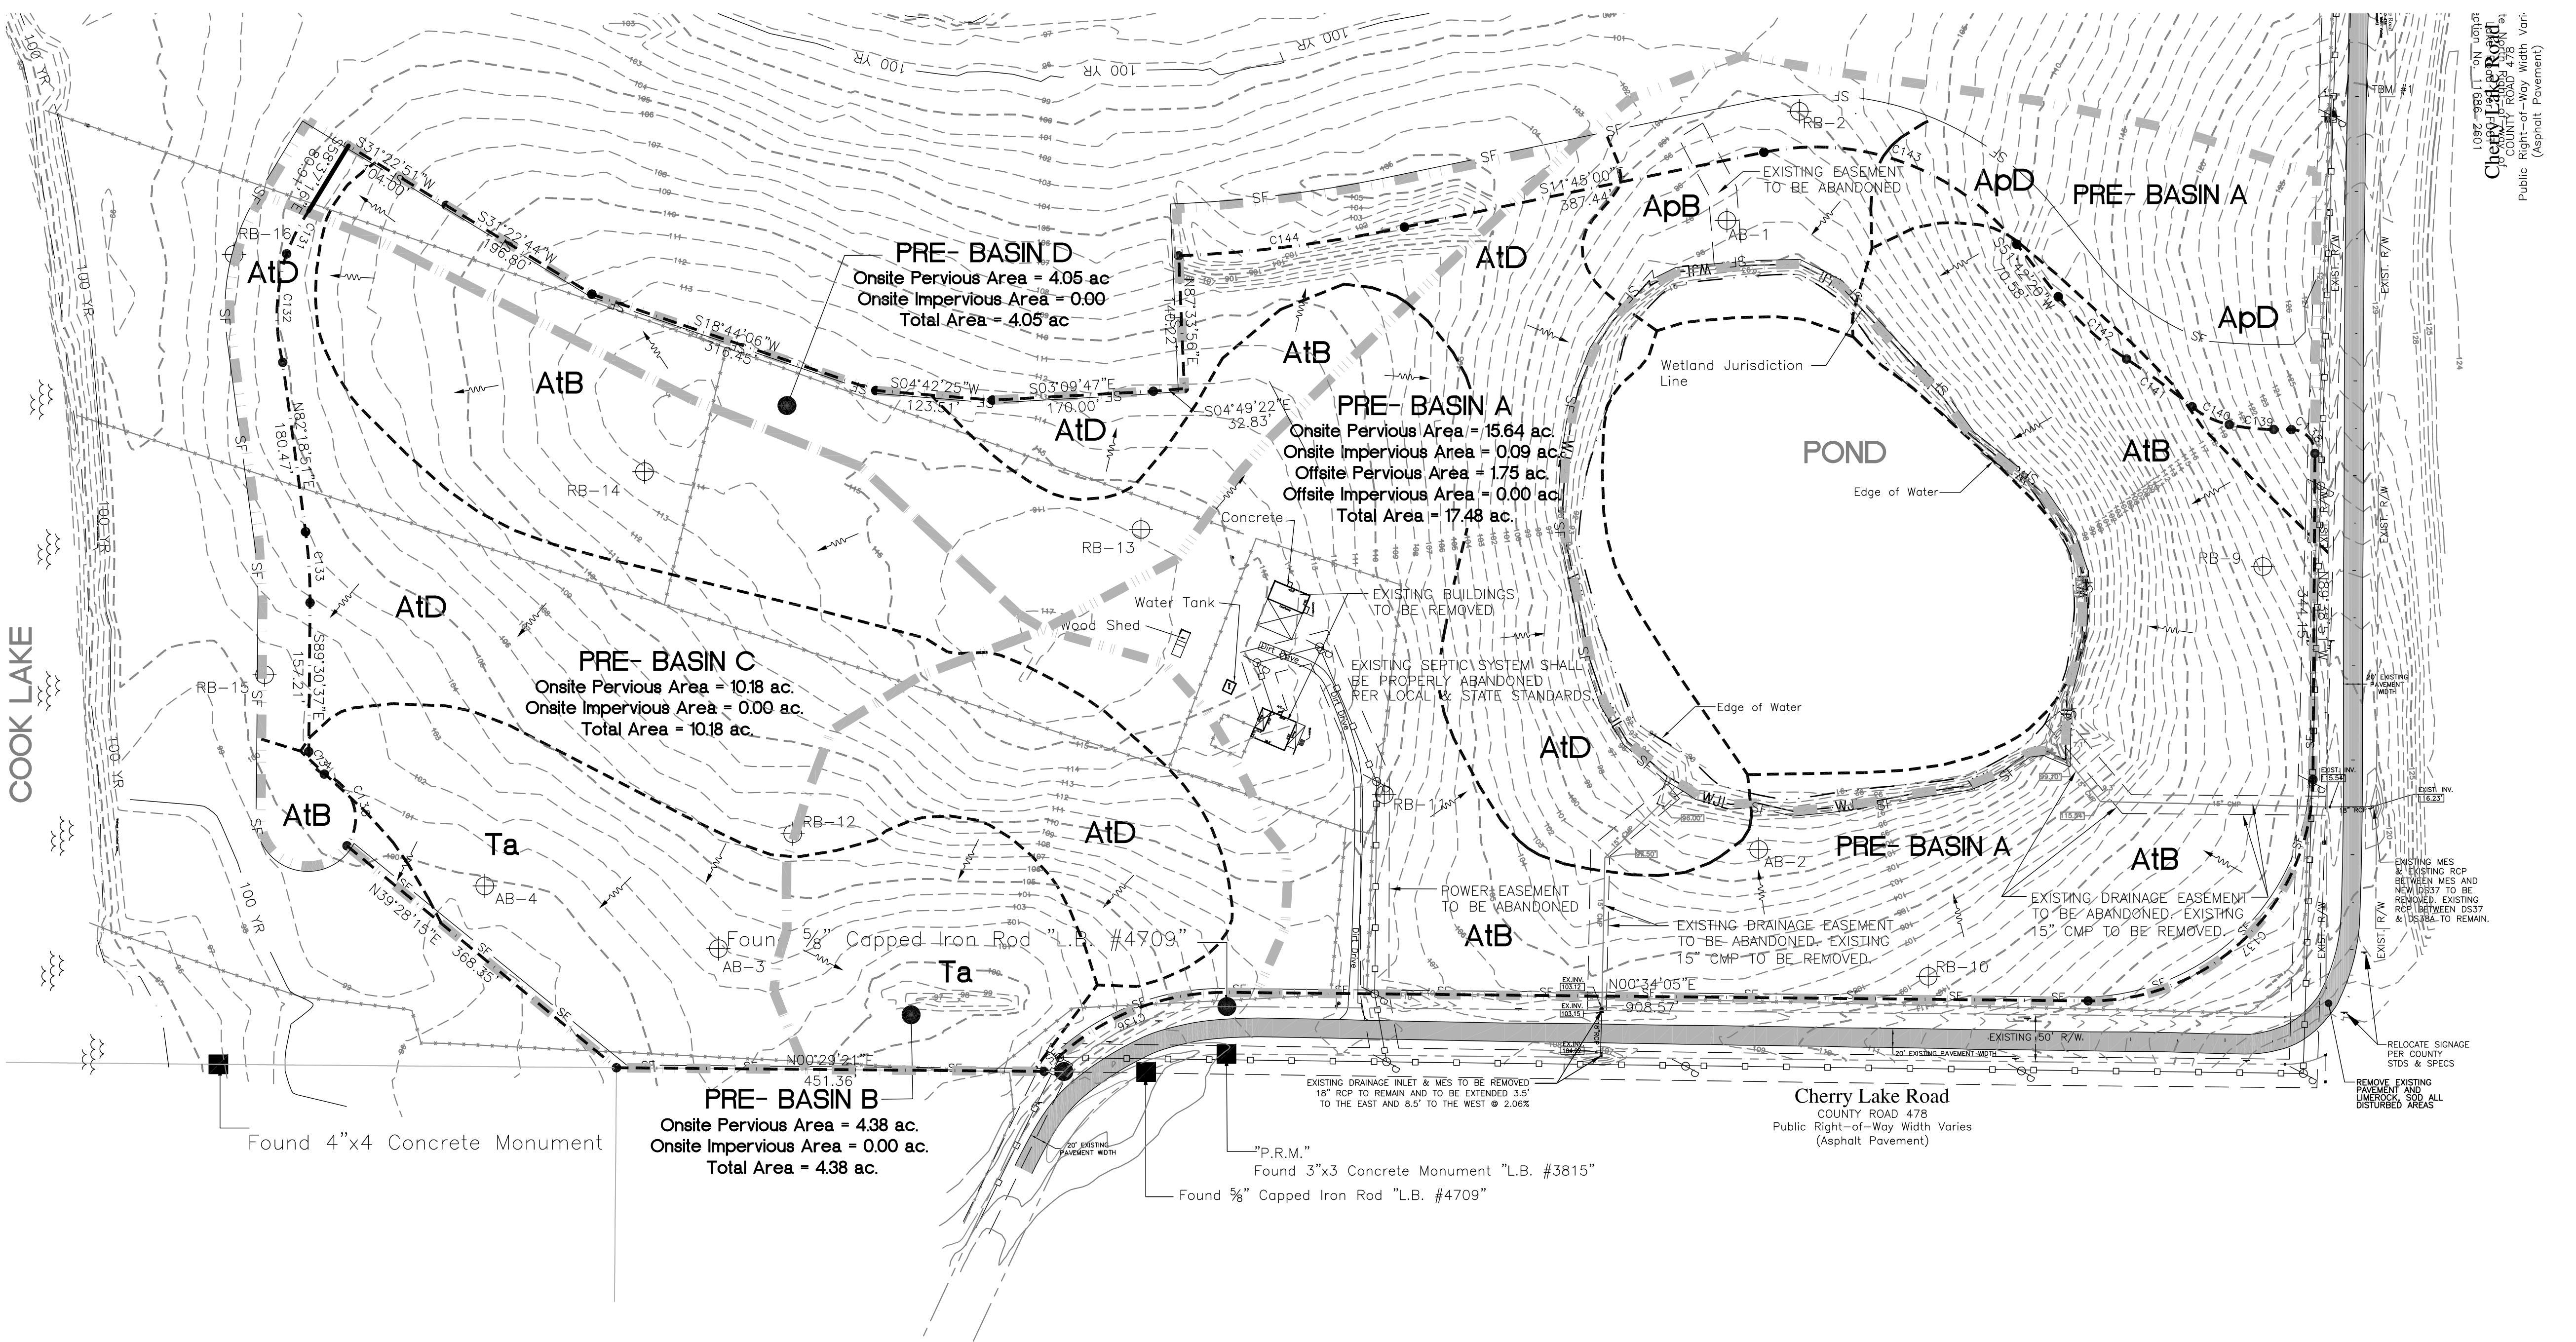
NOTES:
THE PROPERTY LINE BOUNDARY INFORMATION AND OFFSITE EASEMENT INFORMATION SHOWN HEREON IS BASED ON PROPOSED OWNERSHIP AND PROPOSED EASEMENT AGREEMENTS WITH THE ADJACENT PROPERTY OWNER(S). A PORTION OF THE PROPERTY LOCATED WITHIN THE PROPOSED PROPERTY LINE AND WITHIN THE PROPOSED EASEMENTS SHOWN HEREON IS OWNED BY ENTITIES OTHER THAN THE OWNER INDICATED ON THESE PLANS. AT THE TIME THESE PLANS WERE CERTIFIED BY THE ENGINEER OF RECORD, DEEDS FOR OWNERSHIP AND EASEMENTS HAD NOT BEEN EXECUTED. THIS SUBMITTAL IS BEING MADE FOR REVIEW PURPOSES ONLY.

PRELIMINARY PLAT - FOR REVIEW ONLY - NOT FOR CONSTRUCTION

THOMAS L. KNIGHT
#47614

SPRINGS AT CHERRY LAKE

SECTION 3; TOWNSHIP 22S; RANGE 25E, CITY OF GROVELAND, FLORIDA
OWNER/DEVELOPER: L&D LLC, ET AL
ADDRESS: P.O. BOX 97, BELL, FL 32619 PHONE: (352) 463-2942



Imagery Date: 12/18/2013 28°35'55.36"N

COOK LAKE

2014-500910



Cherry Lake Road
COUNTY ROAD 478
Public Right-of-Way Width Varies
(Asphalt Pavement)

THOMAS L. KNIGHT
#47614

SHEET: 3 OF 12

PROJECT NO.
K06-11

AERIAL
OVERLAY

DATE:
NOVEMBER 2014
DRAWN BY:
TLK
APPROVED BY:
TLK
SCALE:
1" = 100'
REVISIONS:

SPRINGS AT CHERRY LAKE
COUNTY ROAD 478
Public Right-of-Way Width Varies
(Asphalt Pavement)

SECTION 3; TOWNSHIP 22S; RANGE 23E, CITY OF GROVELAND, FLORIDA
OWNER/DEVELOPER: L&D LLC, ET AL
ADDRESS: P.O. BOX 97, BELL, FL 32619 PHONE: (352) 463-2942

THOMAS L. KNIGHT, P.E.
PROFESSIONAL ASSOCIATION
Planning, Design, Permitting, Inspection
1135 EAST AVENUE, CLERMONT, FL 34711
PHONE: (352) 394-8514 FAX: (352) 394-8541
Certificate of Authorization No. 000-29972

SPRINGS AT CHERRY LAKE

SECTION 3: TOWNSHIP 22S; RANGE 25E, CITY OF GROVELAND, FLORIDA
OWNER/DEVELOPER: L&D LLC ET AL
ADDRESS: P.O. BOX 97, BELL, FL 33619 PHONE: (352) 463-2942

DATE:	NOVEMBER 2014
DRAWN BY:	TLK
APPROVED BY:	TLK
SCALE:	1" = 100'
REVISIONS:	02/15 REVISED PER TLKPEA 05/15 REVISED PER CITY RAI

PROJECT NO.	K06-11
GEOMETRY PLAN	

CURVE TABLE			
CURVE	LENGTH	RADIUS	DELTA
C1	216.46	256.63	47°57'20"
C2	23.80	25.00	54°32'58"
C3	15.47	25.00	35°27'02"
C4	39.27	25.00	90°00'00"
C5	26.58	393.66	3°52'09"
C6	86.52	393.66	12°35'34"
C7	42.34	393.66	6°09'46"
C8	48.01	525.00	5°14'23"
C9	87.20	525.00	9°30'58"
C10	85.23	525.00	9°18'04"
C11	85.54	525.00	9°20'25"
C12	88.37	525.00	9°38'38"
C13	149.77	525.00	16°20'44"
C14	154.40	475.00	18°37'28"
C15	47.23	25.00	08°14'43"
C16	30.77	25.00	70°31'44"
C17	91.71	50.00	05°05'17"
C18	126.92	50.00	45°26'26"
C19	67.78	475.00	8°10'32"
C20	142.00	258.42	31°29'07"
C21	62.51	257.95	13°53'02"
C22	50.66	207.93	13°57'25"
C23	42.30	25.00	96°57'00"
C24	86.24	228.00	12°38'20"
C25	12.49	200.31	11°19'43"
C26	49.69	223.60	9°37'12"
C27	30.31	845.00	20°30'00"
C28	82.69	845.00	5°36'25"
C29	49.53	845.00	3°17'29"
C30	36.00	475.00	4°20'32"
C31	107.16	475.00	12°55'32"
C32	107.16	475.00	12°56'32"
C33	106.40	475.00	12°50'03"
C34	4.69	475.00	03°33'56"
C35	78.16	763.19	5°52'04"
C36	82.46	763.19	6°11'27"
C37	31.57	763.19	2°22'12"
C38	43.61	25.00	99°56'35"
C39	63.44	50.00	2241°43"
C40	20.86	50.00	2354°33"
C41	57.99	50.00	6627°06"
C42	44.83	50.00	5122°12"
C43	16.06	25.00	3647°58"
C44	29.83	250.00	6°50'08"
C45	36.69	250.00	8°24'30"
C46	73.49	250.00	16°50'33"
C47	31.43	25.00	72°01'24"
C48	73.19	125.00	33°32'48"
C49	20.76	125.00	9°31'01"
C50	68.25	125.00	31°17'09"
C51	27.31	180.00	8°41'39"
C52	221.42	180.00	70°28'44"
C53	34.70	180.00	11°02'38"
C54	30.77	25.00	70°31'44"
C55	62.90	50.00	72°04'55"
C56	58.78	50.00	6°20'15"
C57	96.94	50.00	11°05'20"
C58	362.15	230.00	9°13'00"
C59	124.62	175.00	40°48'10"
C60	16.29	75.00	12°26'44"
C61	51.64	25.00	18°21'38"
C62	39.27	25.00	90°00'00"
C63	370.02	235.00	89°04'45"
C64	39.27	25.00	90°00'00"
C65	47.37	229.00	11°51'06"
C66	43.96	93.00	27°05'00"
C67	85.51	78.00	6°13'29"
C68	98.00	300.00	18°42'56"
C69	68.94	50.00	11°05'20"
C70	281.18	270.00	59°40'08"
C71	67.27	142.62	2°41'53"
C72	82.57	142.62	3°18'42"
C73	90.00	142.62	3°36'38"
C74	631.47	158.62	9°37'12"
C75	137.02	320.00	24°31'59"
C76	217.38	320.00	38°55'21"
C77	211.27	250.00	48°25'07"
C78	81.13	50.00	92°57'50"
C79	80.73	275.00	12°39'13"
C80	60.73	275.00	12°39'13"
C81	75.66	795.00	6°27'11"
C82	77.25	795.00	5°34'01"
C83	14.42	525.00	13°44'25"
C84	81.46	525.00	8°53'26"
C85	81.46	525.00	8°53'26"
C86	81.46	525.00	8°53'26"
C87	81.46	525.00	8°53'26"
C88	58.17	275.00	6°27'28"
C89	23.90	713.19	1°55'13"
C90	98.37	713.19	7°54'11"
C91	57.32	713.19	4°36'19"
C92	33.90	25.00	7741°03"
C93	16.41	100.00	9°24'10"
C94	5.08	100.00	5°24'47"
C95	39.27	25.00	90°00'01"
C96	25.30	443.59	3°16'02"
C97	80.91	443.59	10°27'04"
C98	68.96	443.59	8°54'23"
C99	147.00	443.59	8°54'23"

CURVE TABLE			
CURVE	LENGTH	RADIUS	DELTA
C9	13.28	125.00	3°17'09"
C10	107.16	180.00	12°55'33"
C101	106.49	475.00	12°50'43"
C102	106.43	475.00	12°50'18"
C103	106.43	475.00	12°50'18"
C104	52.54	475.00	6°20'15"
C105	36.57	525.00	5°59'27"
C106	81.22	525.00	8°51'51"
C107	52.86	525.00	5°46'09"
C108	31.31	25.00	71°45'17"
C109	74.91	525.00	8°10'32"
C110	68.84	525.00	18°21'38"
C111	54.22	230.02	1°30'23"
C112	56.60	23.95	16°51'33"
C113	60.55	233.42	14°51'44"
C114	68.52	23.95	16°49'05"
C115	71.35	500.00	8°10'32"
C116	132.41	500.00	12°39'13"
C117	55.21	250.00	12°39'13"
C118	157.72	230.00	11°01'33"
C119	380.42	500.00	43°35'55"
C120	185.70	738.19	14°25'43"
C121	322.79	205.00	9°13'00"
C122	104.82	150.00	40°48'10"
C123	71.30	100.00	40°48'23"
C124	165.31	418.63	22°37'25"
C125	518.24	500.00	59°23'17"
C126	162.53	500.00	50°23'17"
C127	235.67	140.32	15°15'15"
C128	326.72	295.00	6°27'26"
C129A	89.83	275.00	18°42'56"
C129B	38.06	81.00	24°10'07"
C129C	117.99	191.00	25°23'44"
C130	107.48	500.00	12°18'57"
C131	50.66	207.95	13°57'25"
C132	116.06	208.42	31°54'21"
C133	74.91	525.00	8°10'32"
C134	30.77	25.00	20°31'44"
C135	135.37	25.00	10°50'17"
C136	216.46	258.63	47°57'26"
C137	370.01	234.92	9°14'38"
C138	76.76	50.00	87°57'53"
C139	106.04	300.00	3015'06"
C140	152.19	300.00	2903'58"
C141	299.03	270.00	6327'20"
C142	240.40	1428.62	9°38'29"
C143</			


SPRINGS AT CHERRY LAKE

SECTION 3; TOWNSHIP 22S; RANGE 25E, CITY OF GROVELAND, FLORIDA
OWNER/DEVELOPER: L&D LLC, ET AL
ADDRESS: P.O. BOX 97, BELL, FL 32619 PHONE: (352) 463-2942


DATE: NOVEMBER 2014
DRAWN BY: TLK
APPROVED BY: TLK
SCALE: 1"=100'
REVISIONS: 05/15 REVISED FOR CITY RAI

PROJECT NO. K06-11
DRAINAGE PLAN

SHEET: 5 OF 12

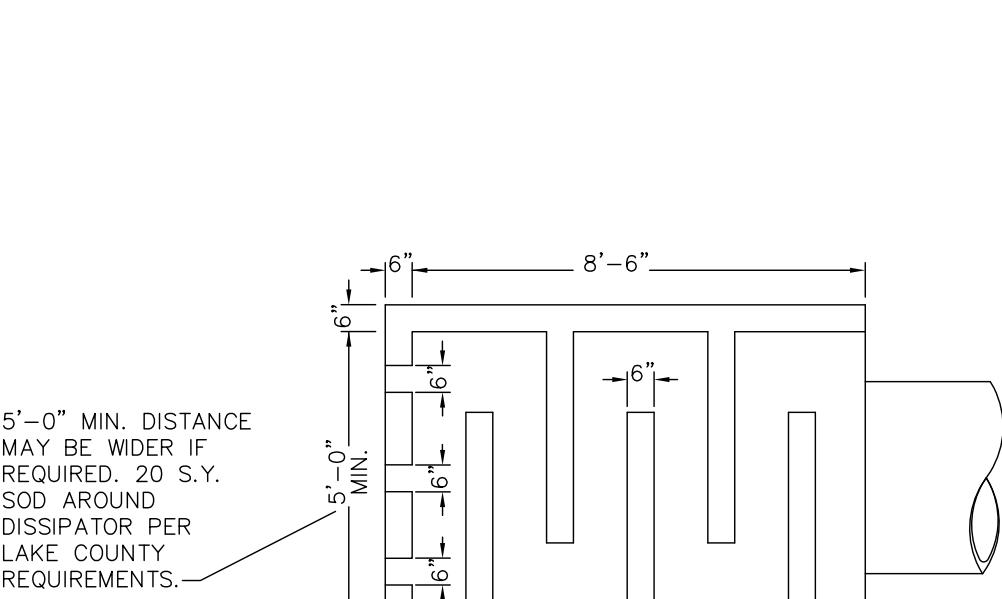

PLAN VIEW

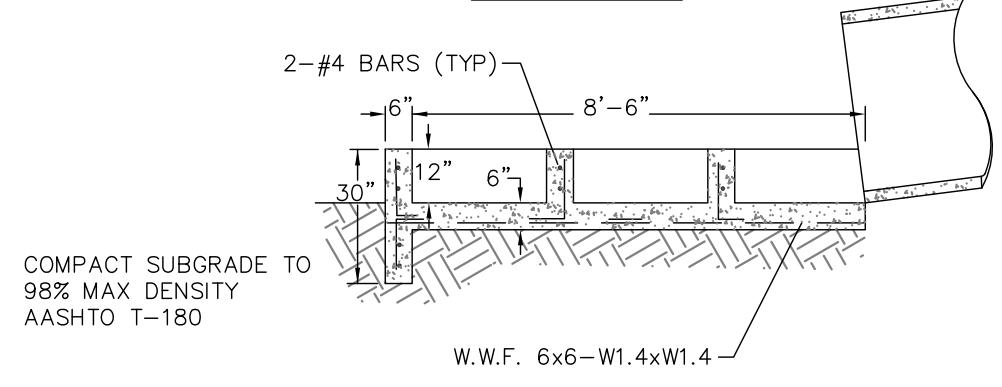

SECTION VIEW

ENERGY DISSIPATOR DETAIL


N.T.S.

CONSTRUCTION TO BE 3000 P.S.I.
PRECAST OR IN PLACE STRUCTURE
SHOP DRAWING REQUIRED.

- GENERAL NOTES:**
1. THE PROPOSED STORMWATER MANAGEMENT SYSTEM WILL BE OPERATED AND MAINTAINED BY THE SPRINGS AT CHERRY LAKE HOMEOWNERS ASSOCIATION.
 2. ALL STORMWATER RETENTION AREA SIDE SLOPES WILL BE SODDED.
 3. SOD ALL SLOPES IN EXCESS OF 5:1. ALL DISTURBED AREAS SHALL BE SEED AND MULCHED UNLESS OTHERWISE NOTED.
 4. ALL CONSTRUCTION SHALL CONFORM TO AND SHALL BE INSTALLED AND CLEARED FOR SERVICE IN ACCORDANCE WITH THE CITY OF GROVELAND STANDARDS UNLESS STATED OTHERWISE ON THE PLANS.
 5. ALL EARTHWORK OPERATIONS SHALL BE IN ACCORDANCE WITH THE SPECIFICATIONS, PLANS AND RECOMMENDATIONS OF THE GEOTECHNICAL ENGINEER (AS APPLICABLE).
 6. WHEN TRENCH EXCAVATION EXCEEDS (5') FIVE IN DEPTH:
 - A. CONTRACTOR SHALL CONFORM TO OSHA STD. 29CFR. SECTION 1926.650 WHICH IS INCORPORATED IN FL. STATE 90-96.
 - B. THE CONTRACTOR SHALL PROVIDE WRITTEN ASSURANCE OF COMPLIANCE WITH THIS LAW.
 - C. TRENCH SAFETY SYSTEM SHALL BE DESIGNED BY THE CONTRACTOR.
 7. ALL PIPES SHALL HAVE A MINIMUM COVER OF 36 INCHES OF COVER.
 8. ALL DRAINAGE PIPES SHALL BE REINFORCED CONCRETE PIPE ONLY, A MINIMUM DIAMETER OF 18 INCHES, AND CLASS III, UNLESS OTHERWISE NOTED.
 9. DRAINAGE STRUCTURE TOP ELEVATION REFERS TO TOP OF FINISHED STRUCTURE. CONTRACTOR SHALL SCHEDULE A PRE-CONSTRUCTION MEETING WITH THE CITY OF GROVELAND AND THE ENGINEER OF RECORD.




10. THE CONTRACTOR SHALL ENSURE THAT ALL PERMITS FOR CONSTRUCTION ARE OBTAINED PRIOR TO STARTING WORK. ALL PERMITS SHALL BE PROVIDED TO THE CITY OF GROVELAND PRIOR TO STARTING WORK.
11. CONTRACTOR TO COORDINATE WITH UTILITY COMPANIES PRIOR TO ANY CONSTRUCTION ACTIVITY FOR DIG PERMITS - ELECTRICAL PERMITS OR OTHER PERMITS AS APPLICABLE. CONTRACTOR IS TO COORDINATE FULLY WITH UTILITY COMPANIES ON EXACT LOCATION OF UNDERGROUND UTILITIES PRIOR TO EXCAVATION.
12. THE LOCATIONS OF ALL EXISTING UTILITIES AND STORM DRAINAGE SHOWN ON THE PLANS HAVE BEEN DETERMINED FROM AVAILABLE INFORMATION AND ARE GIVEN FOR THE CONVENIENCE OF THE CONTRACTOR. THE OWNER OR ENGINEER ASSUMES NO RESPONSIBILITY FOR INACCURACY. PRIOR TO THE START OF CONSTRUCTION, IT SHALL BE THE CONTRACTOR'S RESPONSIBILITY TO LOCATE VARIOUS UTILITIES AND TO MAKE THE NECESSARY ARRANGEMENTS FOR ANY RELOCATION OF THESE UTILITIES WITH THE UTILITY COMPANY. THE CONTRACTOR SHALL EXERCISE CAUTION WHEN CROSSING ANY UNDERGROUND UTILITY. EXISTING UTILITIES WHICH INTERFERE WITH THE PROPOSED CONSTRUCTION SHALL BE RELOCATED AS DIRECTED ON THESE PLANS.
13. ALL PROPERTY AFFECTED BY THIS WORK SHALL BE RESTORED TO A CONDITION EQUAL TO OR BETTER THAN EXISTED UNLESS SPECIFICALLY EXEMPTED BY THE PLANS. THE COST FOR SUCH RESTORATION SHALL BE INCIDENTAL TO OTHER CONSTRUCTION AND NO EXTRA COMPENSATION WILL BE ALLOWED.
14. PRIOR TO BEGINNING NEW PHASE CONSTRUCTION, THE CONTRACTOR SHALL INSTALL EROSION CONTROL DEVICES AT ALL DOWN STREAM INLETS AND SWALES, IN ADDITION TO THE EROSION CONTROL MEASURES AS SHOWN ON SHEET No. 2.
15. BUILDING HEIGHT WILL NOT EXCEED 35 FEET.
16. ALL SOD INSTALLED ON SITE SHALL BE NON-MUCK GROWN SOD.
17. RECREATION EQUIPMENT MUST BE APPROVED BY THE COMMUNITY DEVELOPMENT DEPARTMENT AND MUST BE INSTALLED BY THE TIME HALF OF THE CERTIFICATES OF OCCUPANCY ARE ISSUED ON THE FIRST DEVELOPMENT.

GRAPHIC SCALE

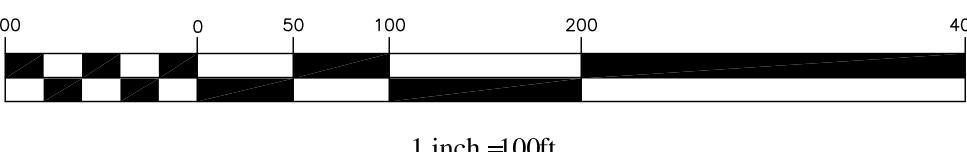

LEGEND

PROPERTY LINE	- - - - -
RIGHT-OF-WAY LINE	- - - - -
ROADWAY CENTERLINE	— — — — —
BUILDING SETBACK LINE	· · · · ·
EASEMENT LINE	— - - - -
EXISTING 5' CONTOUR LINE	— - - - -
EXISTING 1' CONTOUR LINE	— - - - -
STORM DRAINAGE PIPE	— — — — —
SF SF	— — — — —
SILT FENCE	— - - - -
DRAINAGE DIVIDE LINE	— - - - -
WJL WJL	— - - - -
WETLANDS JURISDICTION LINE	— - - - -
SHORELINE	— - - - -
PROPOSED STEM WALL	— - - - -
SLOPE INDICATOR	— - - - -
DRAINAGE FLOW ARROW	— - - - -
PROPOSED MITERED END SECTION W/ ENERGY DISIPATOR	— - - - -
PROPOSED CURB INLET	— - - - -
STORM INLET	— - - - -
STOP SIGN WITH 24" THERMOPLASTIC STOP BAR	○
25 MPH SIGN	○
STREET NAME SIGN	○
25LF-6" WHITE SOLID STRIPE	— — — — —
SODDED OVERFLOW WEIR	— - - - -

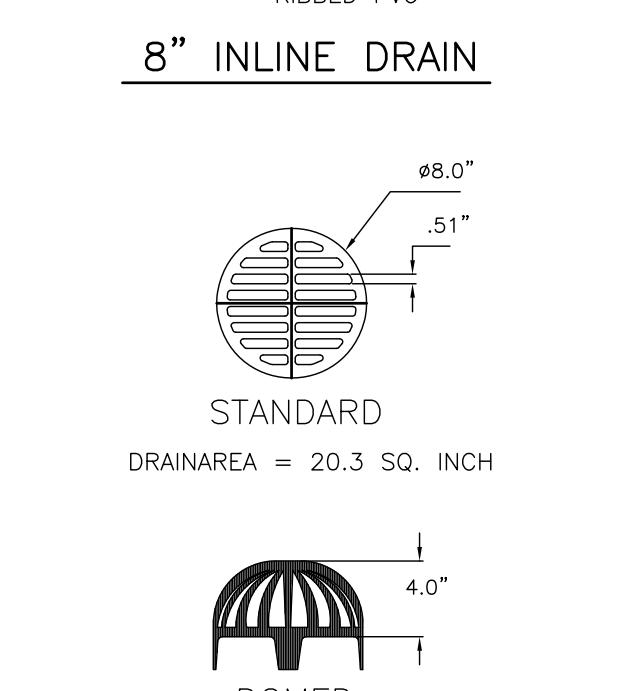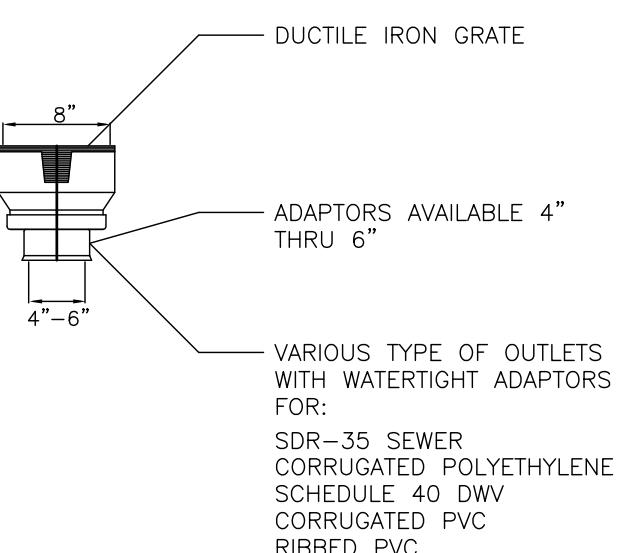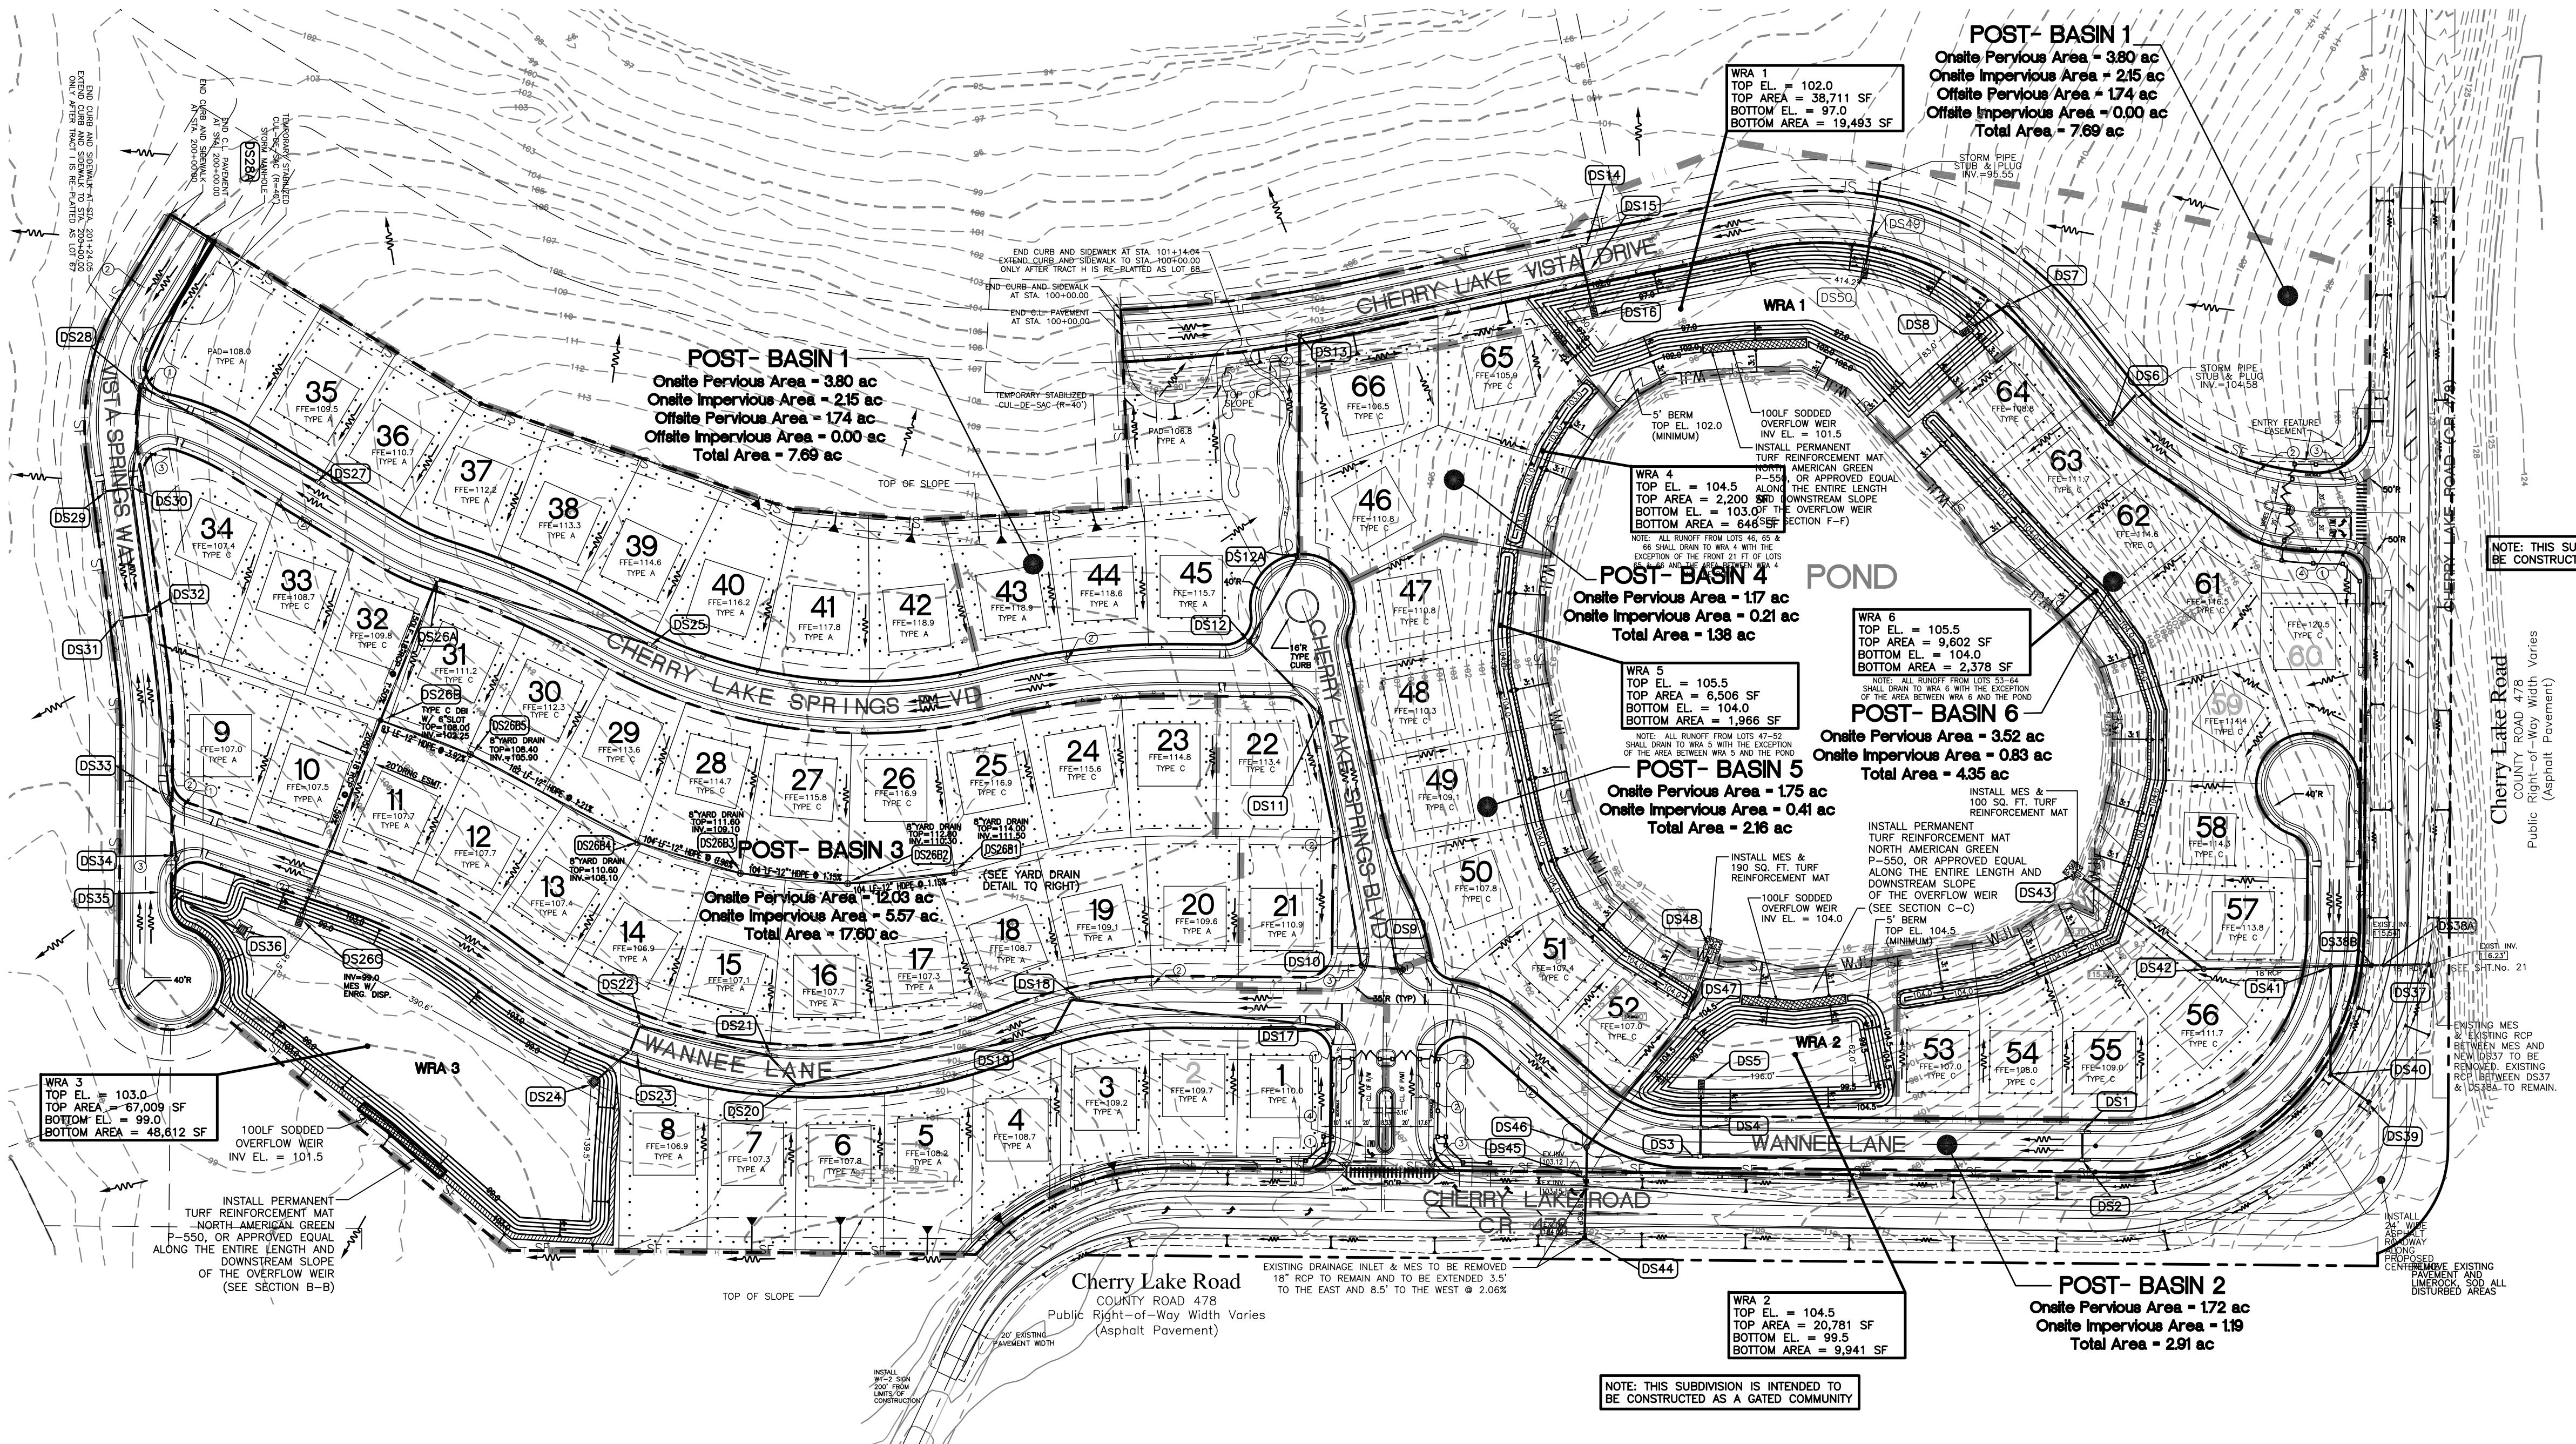

CASTINGS ARE RATED FOR LIGHT WHEEL LOAD TRAFFIC

QUALITY: MATERIAL SHALL CONFORM TO ASTM A48 - CLASS 30B

PAINT: CASTINGS ARE FURNISHED WITH A BLACK PAINT

8" DUCTILE IRON GRATE





N.T.S.

NYLOPLAST 8"

YARD DRAIN DETAIL

THOMAS L. KNIGHT #47614

SHEET: 5 OF 12

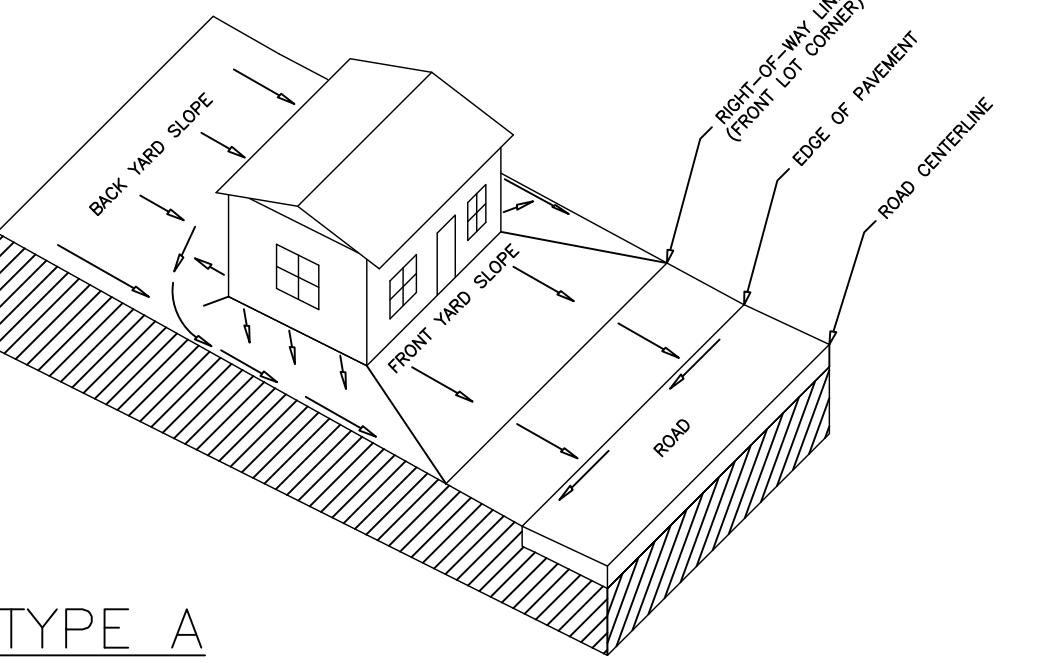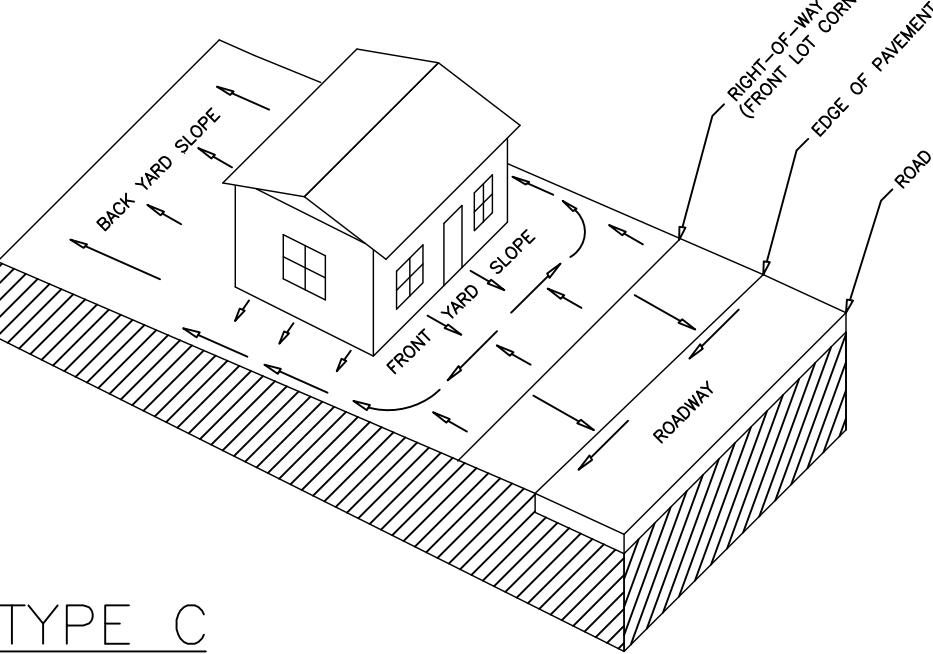


TYPE C

TYPE A



TYPICAL LOT GRADING PLANS

N.T.S.

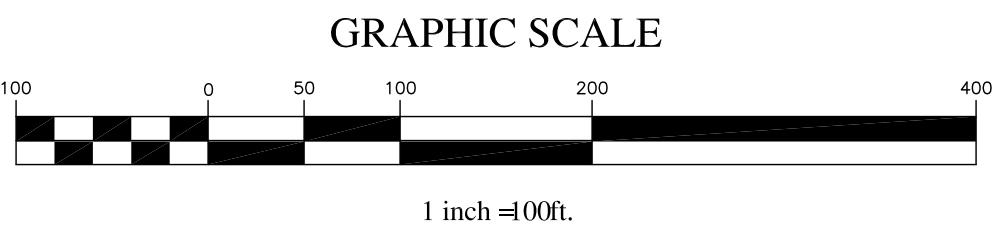

LEGEND

	PROPERTY LINE
	RIGHT-OF-WAY LINE
	ROADWAY CENTERLINE
	EASEMENT LINE
	EXISTING 5' CONTOUR LINE
	EXISTING 1' CONTOUR LINE
	STORM DRAINAGE PIPE
	SILT FENCE
	DRAINAGE DIVIDE LINE
	WETLANDS JURISDICTION LINE
	SHORELINE
	PROPOSED STEM WALL

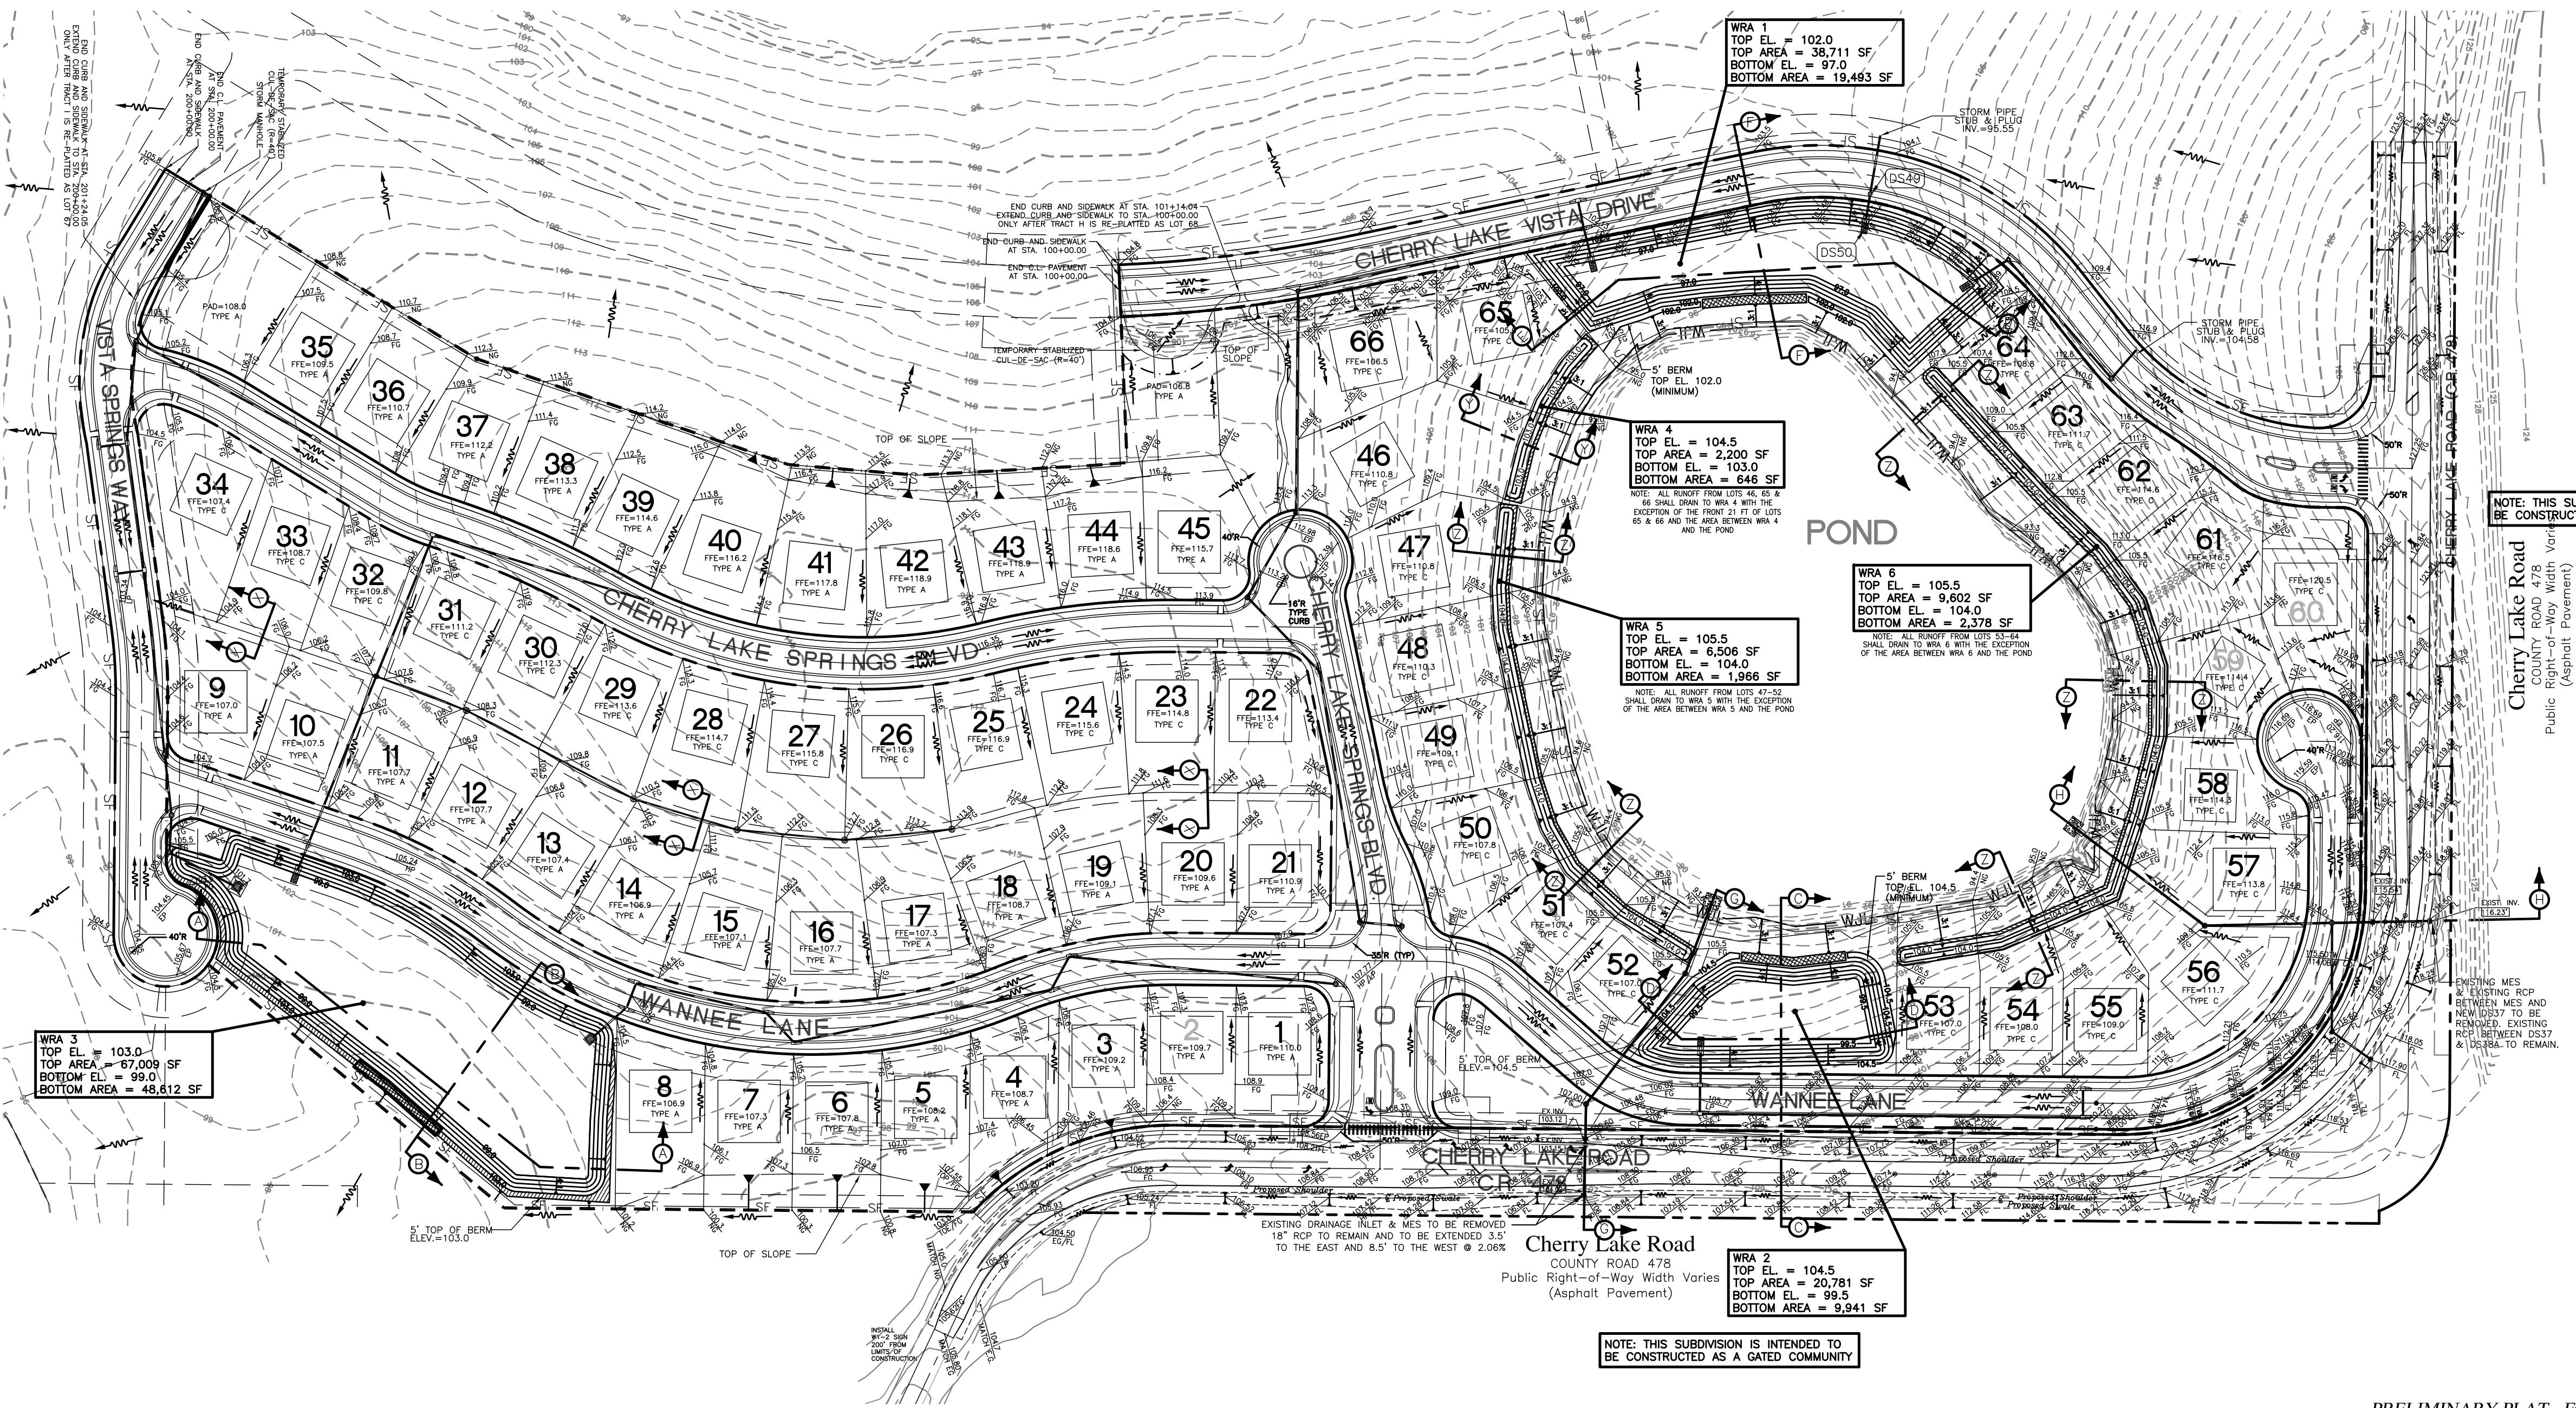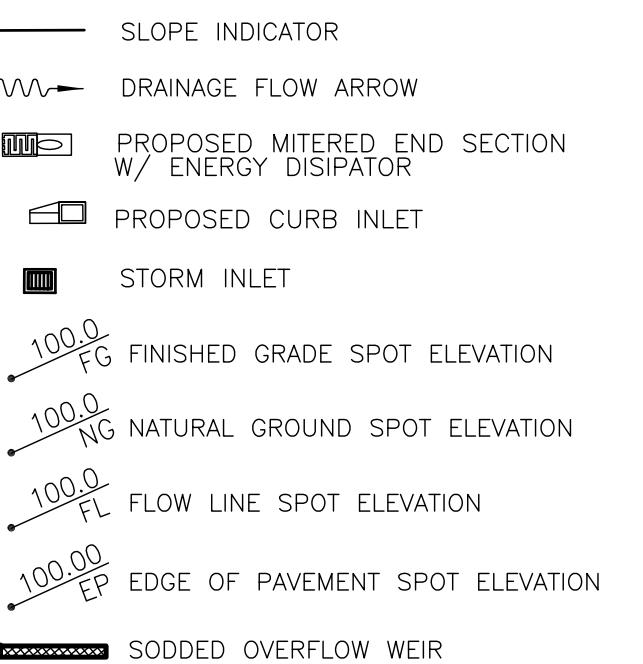

SPRINGS AT CHERRY LAKE

SECTION 3; TOWNSHIP 22S; RANGE 25E, CITY OF GROVELAND, FLORIDA
OWNER/DEVELOPER: L&D LLC, ET AL
ADDRESS: P.O. BOX 97, BELL, FL 32619 PHONE: (352) 463-2942

DATE: NOVEMBER 2014
DRAWN BY: TLK
APPROVED BY: TLK
SCALE: 1"=100'
REVISIONS: 02/15 REVISED PER TLKPEA
05/15 REVISED PER CIRAI

PROJECT NO.
K06-11

GRADING
PLAN


THOMAS L. KNIGHT
#47614

SHEET: 6 OF 12

THOMAS L. KNIGHT, P.E.
PROFESSIONAL ASSOCIATION
Planning, Design, Permitting, Inspection
1135 EAST AVENUE, CLERMONT, FL 34711
PHONE: (352) 394-8514 FAX: (352) 394-8541
Certificate of Authorization No. 0029972


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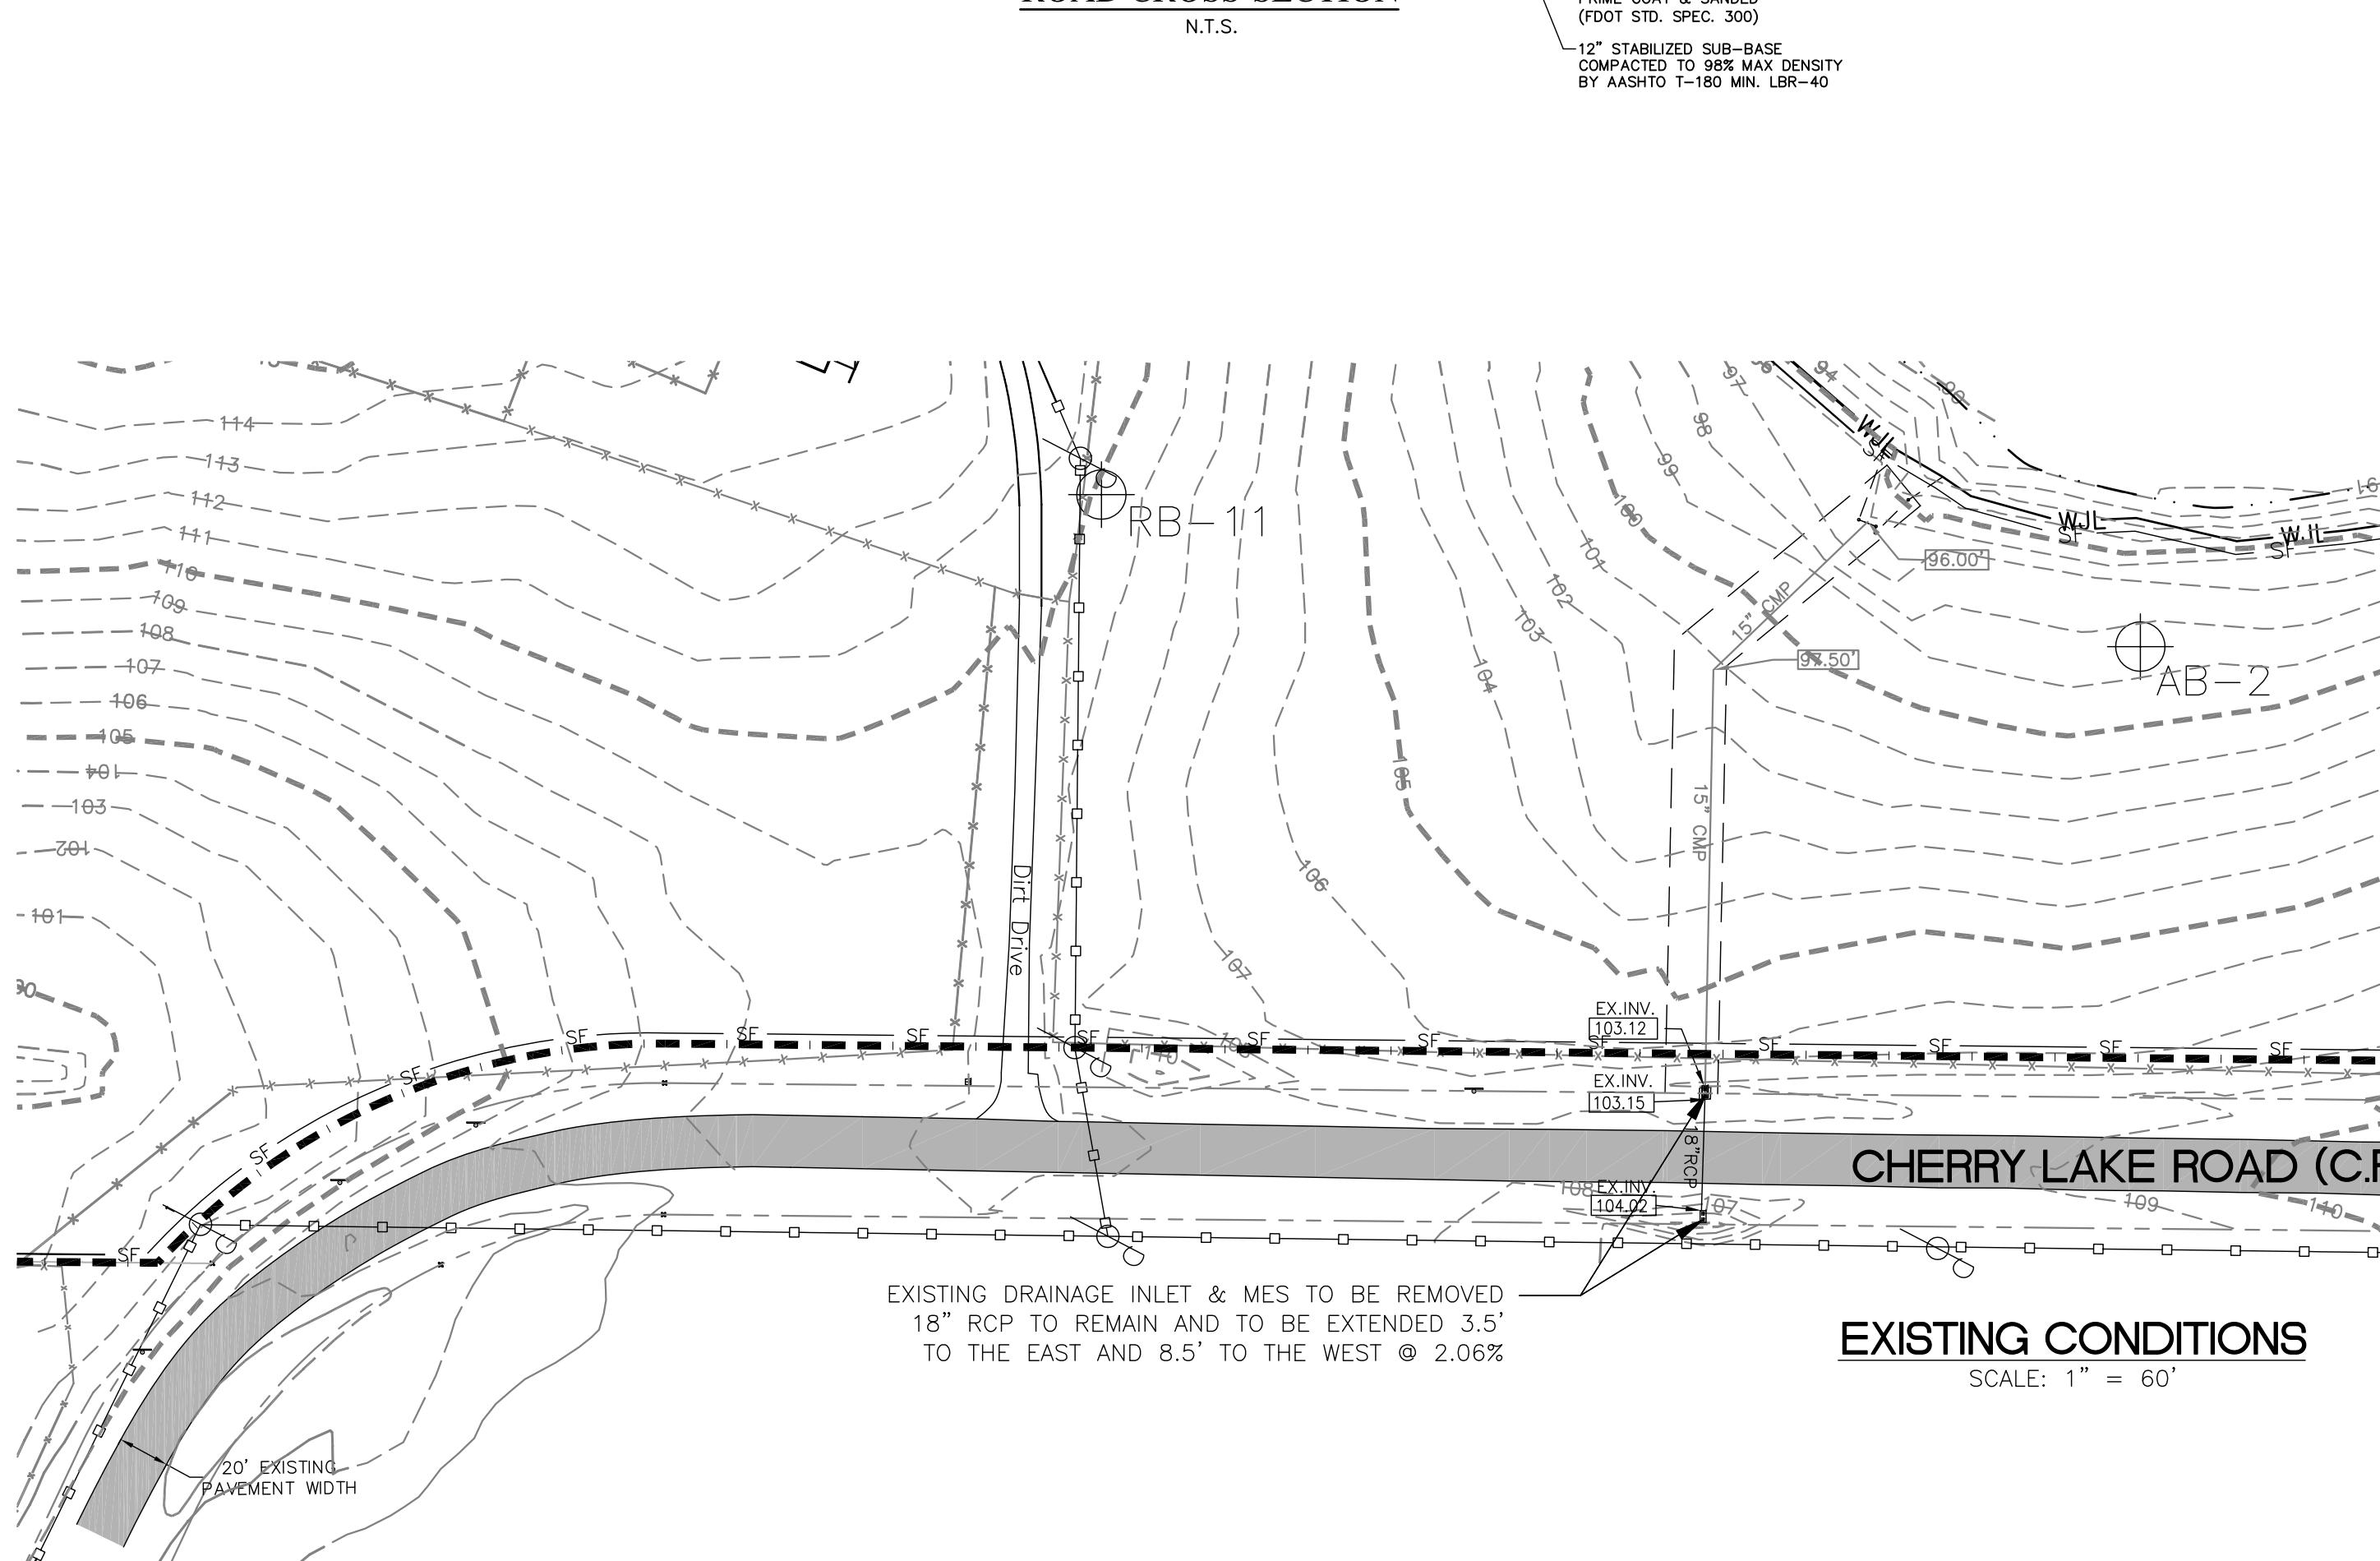
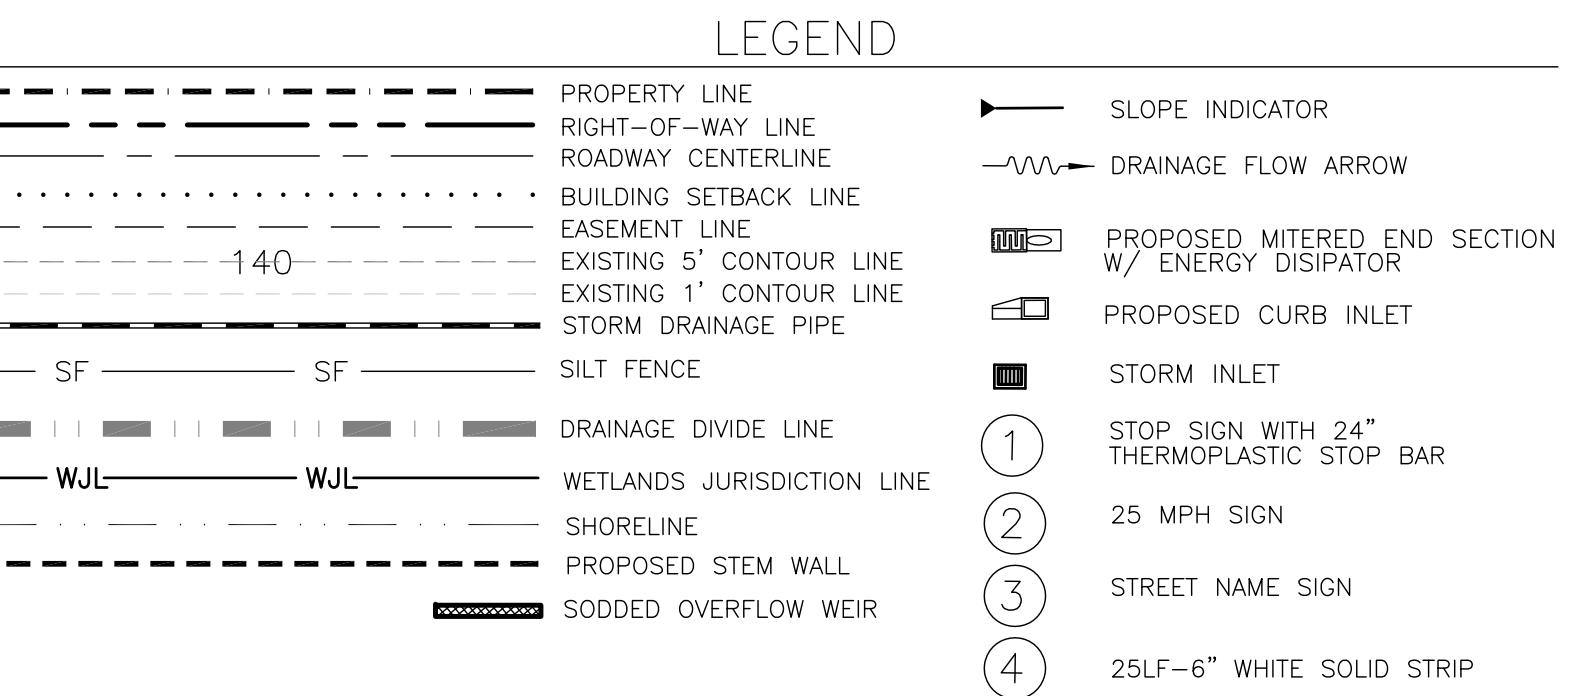
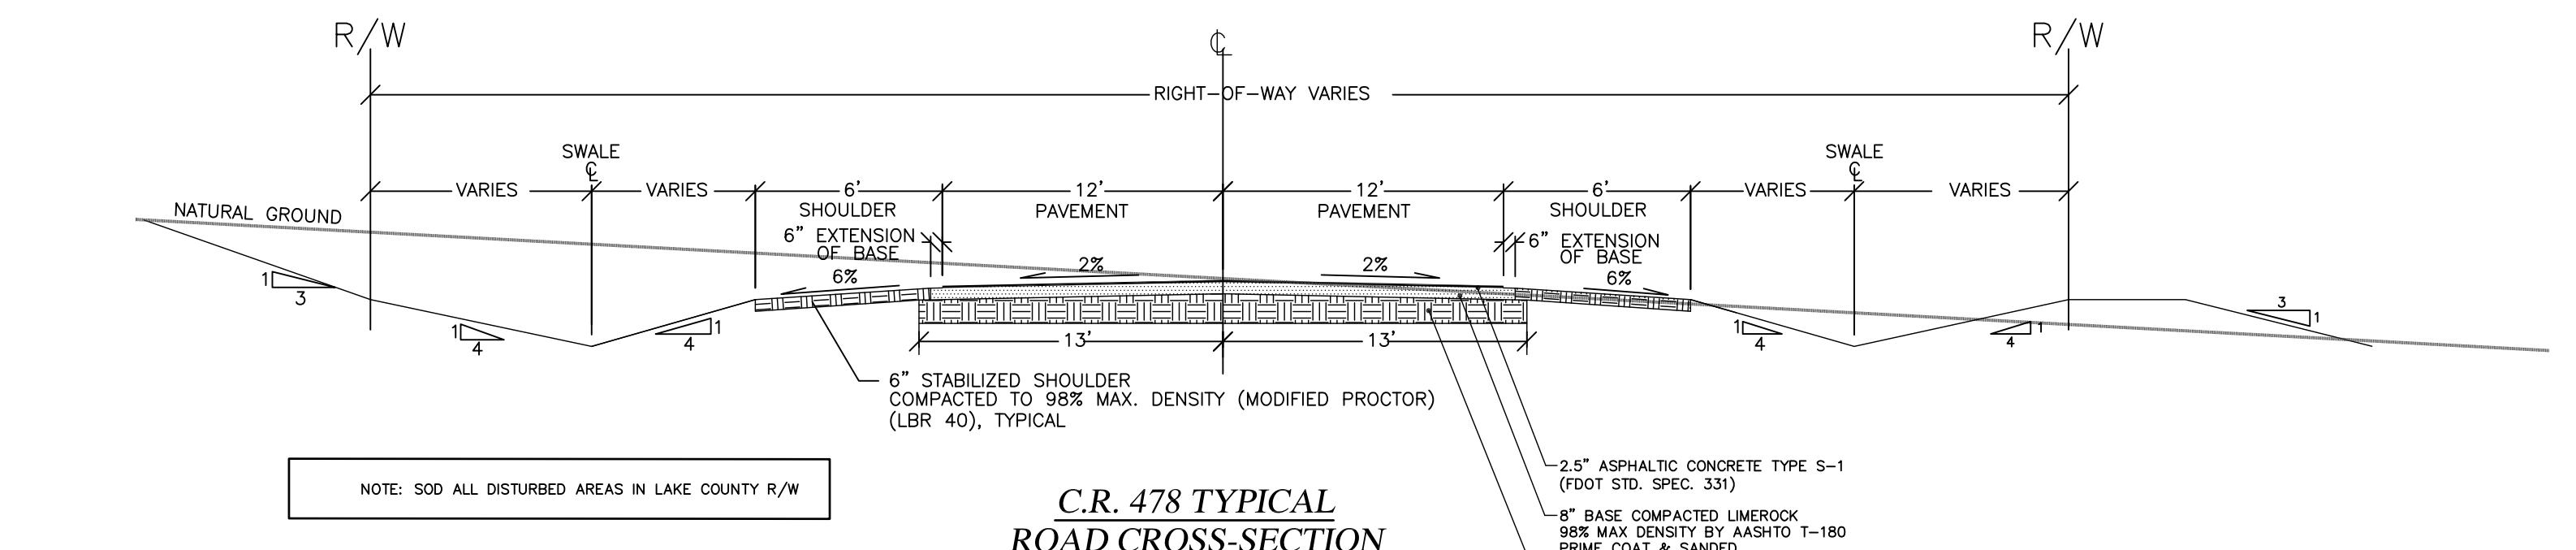
SECTION 3; TOWNSHIP 22S; RANGE 25E, CITY OF GROVELAND, FLORIDA
OWNER/DEVELOPER: L&D LLC, ET AL
ADDRESS: P.O. BOX 97, BELL, FL 32619 PHONE: (352) 463-2942

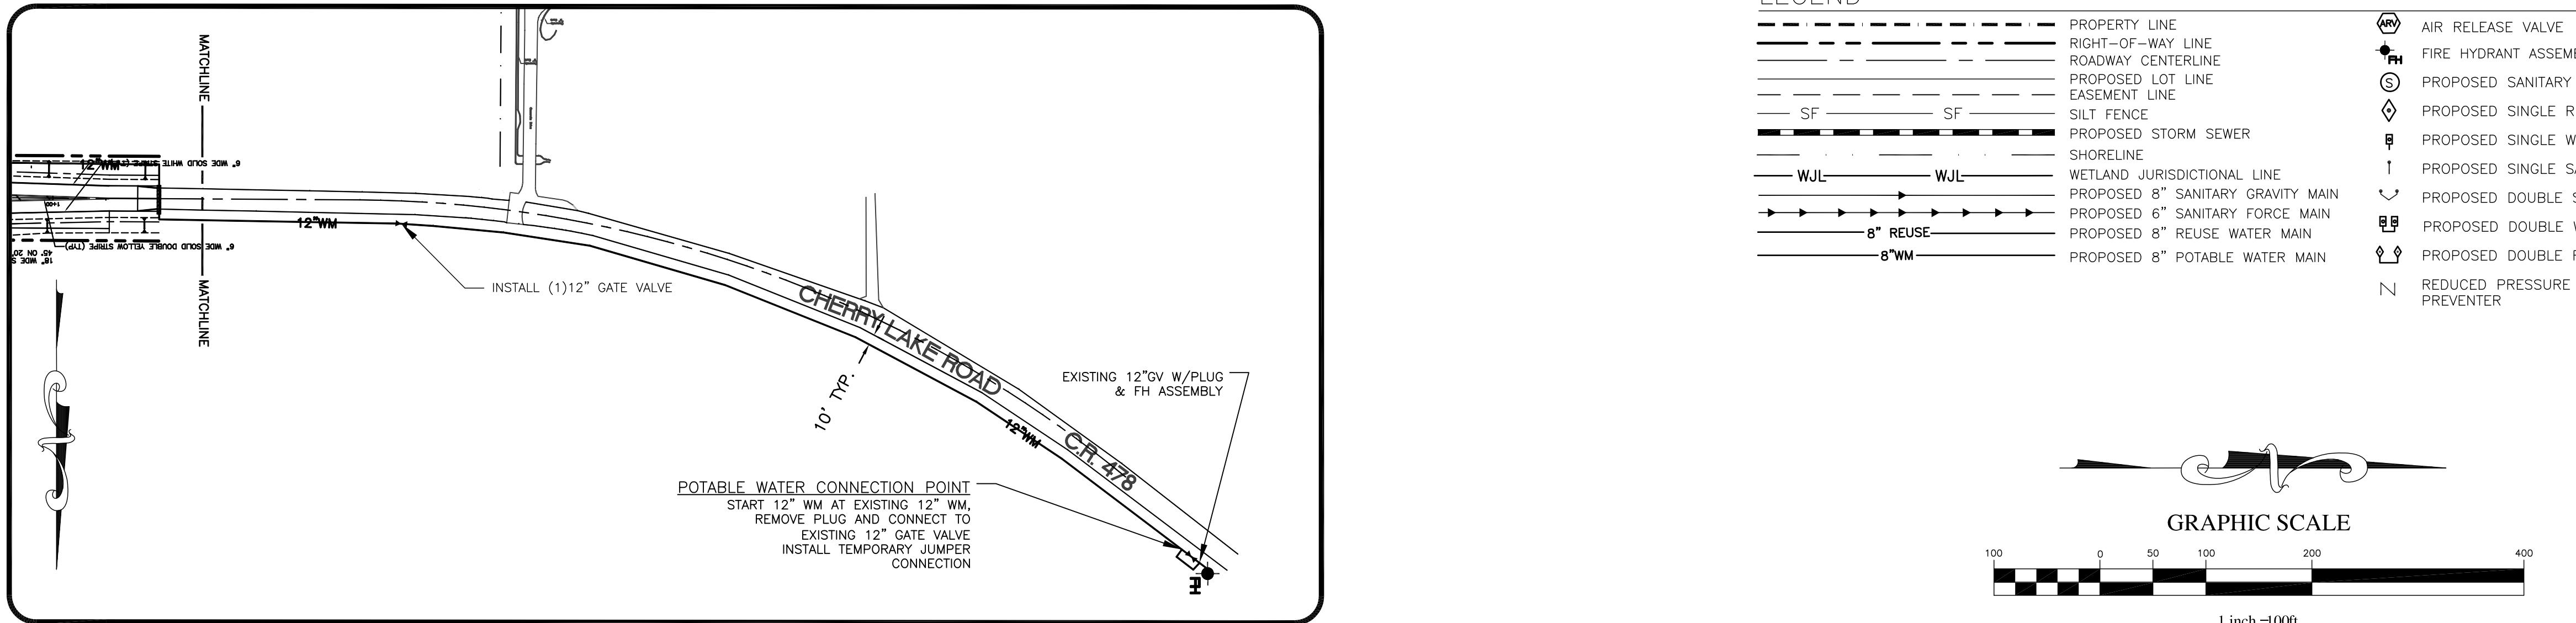

OFFSITE WATER MAIN



SCALE: 1" = 100'



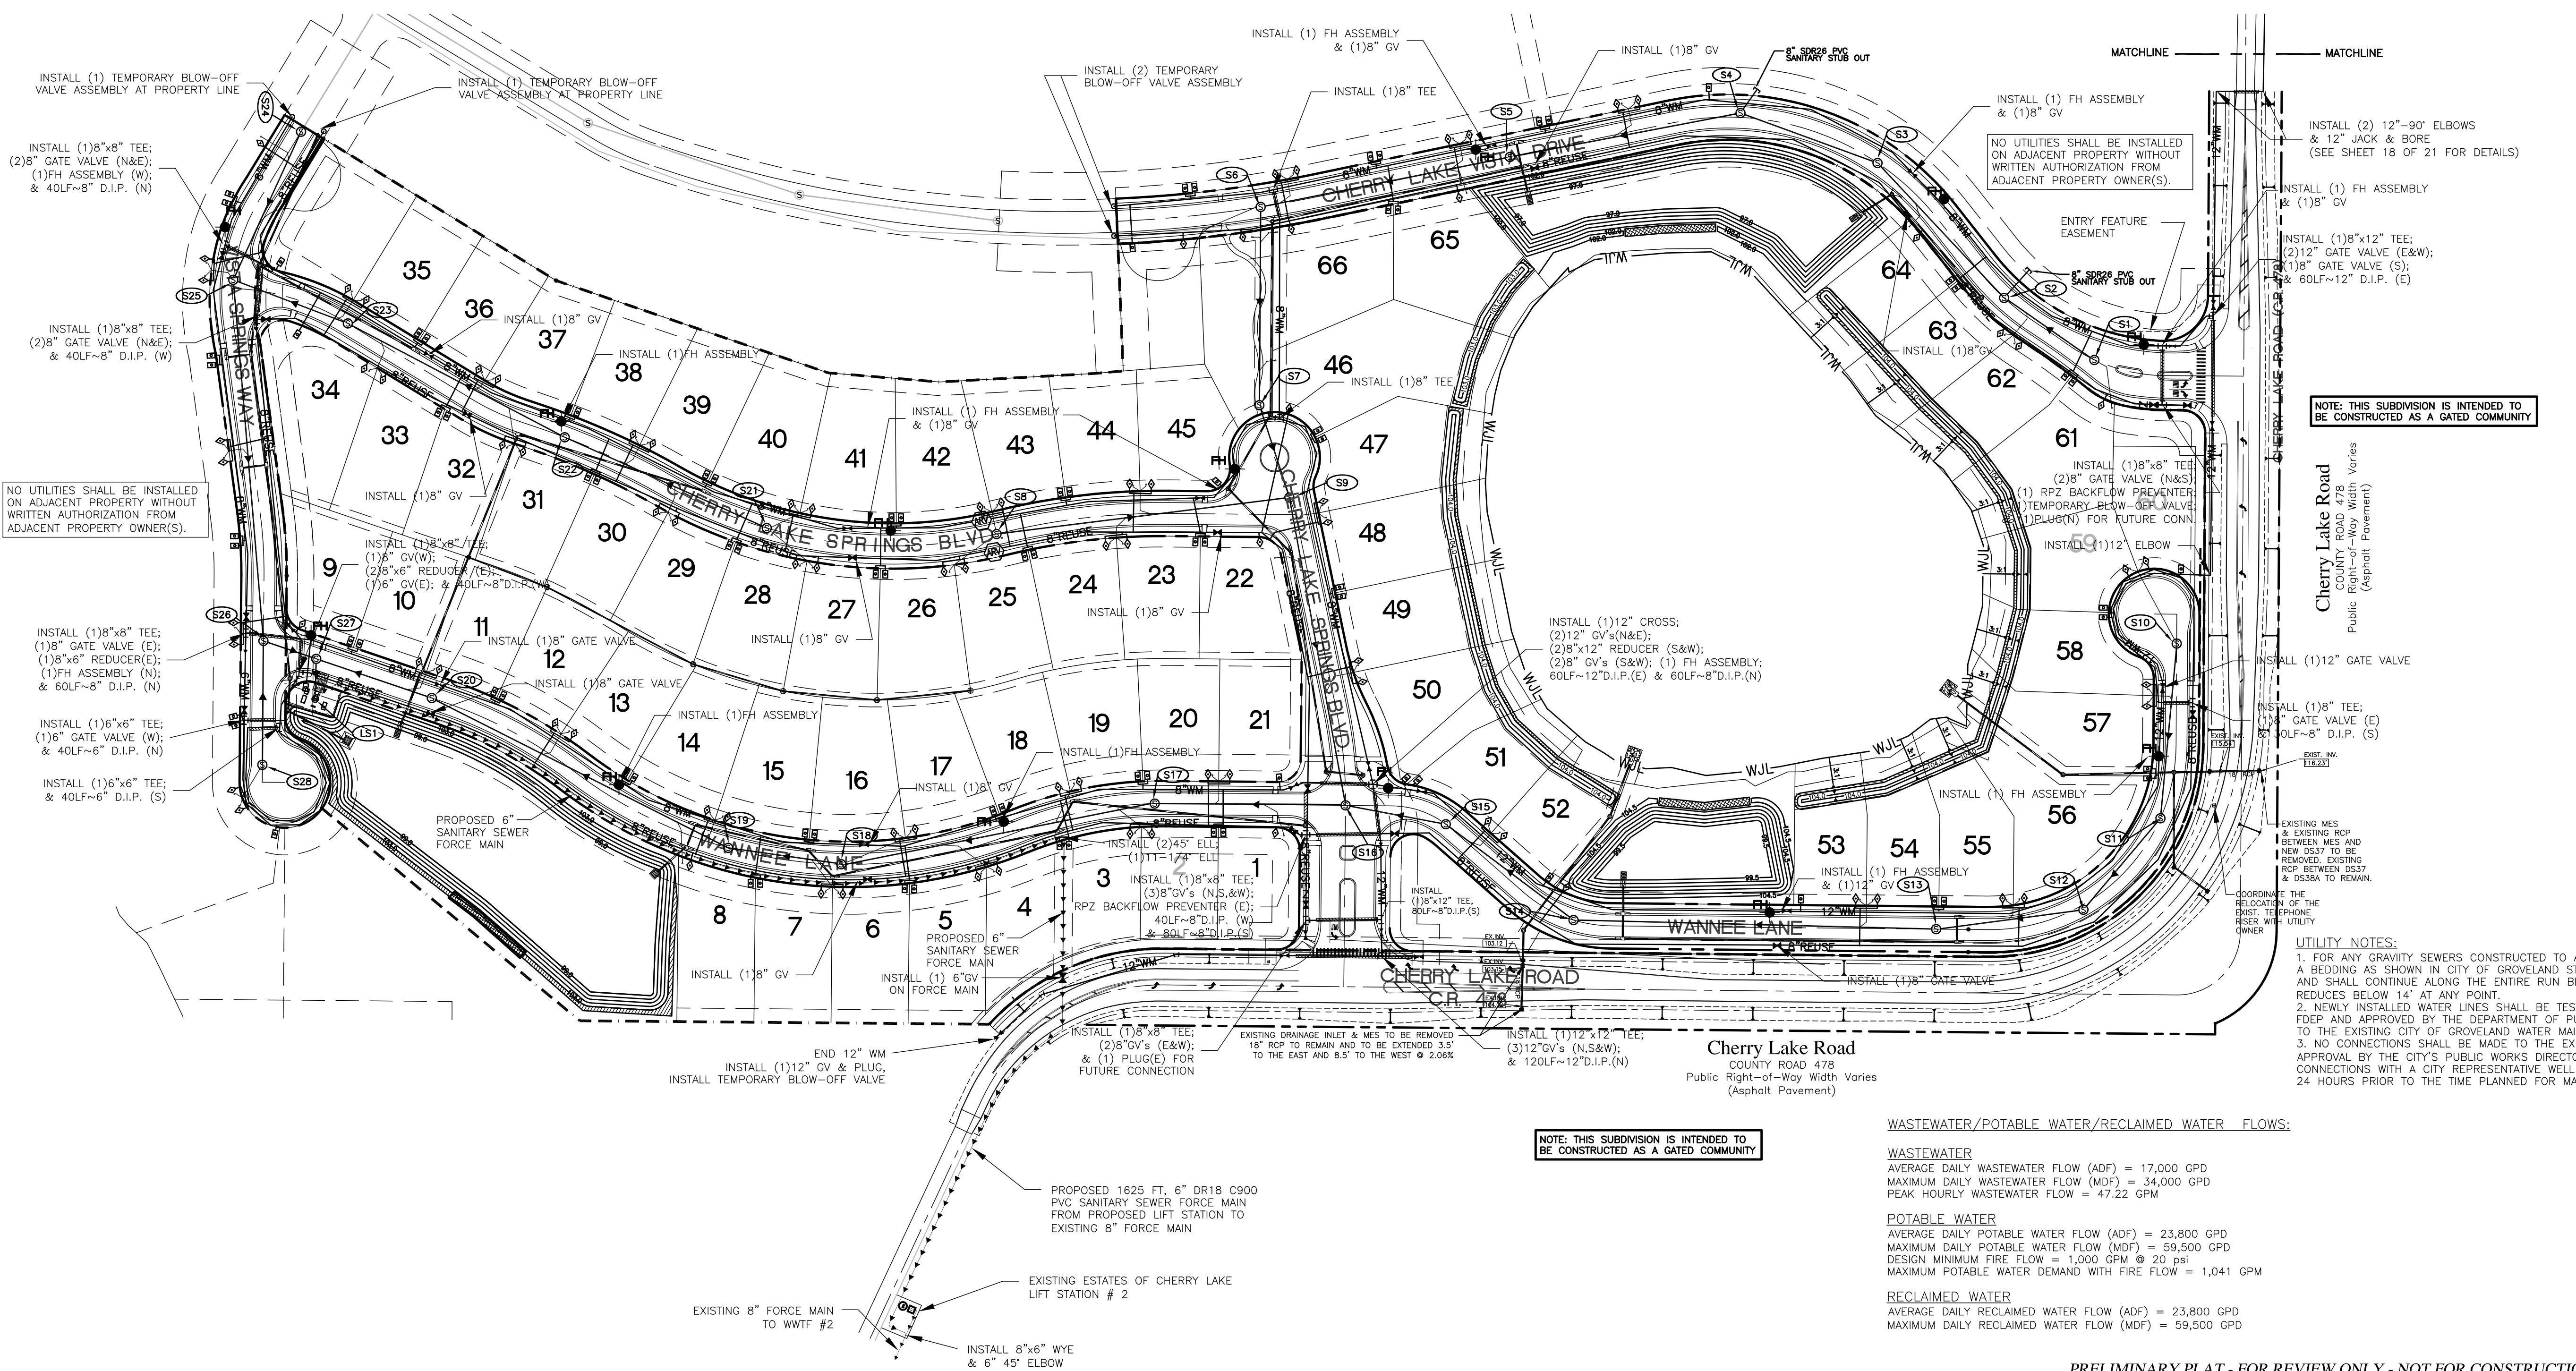


EXISTING CONDITIONS

SCALE: 1" = 60'

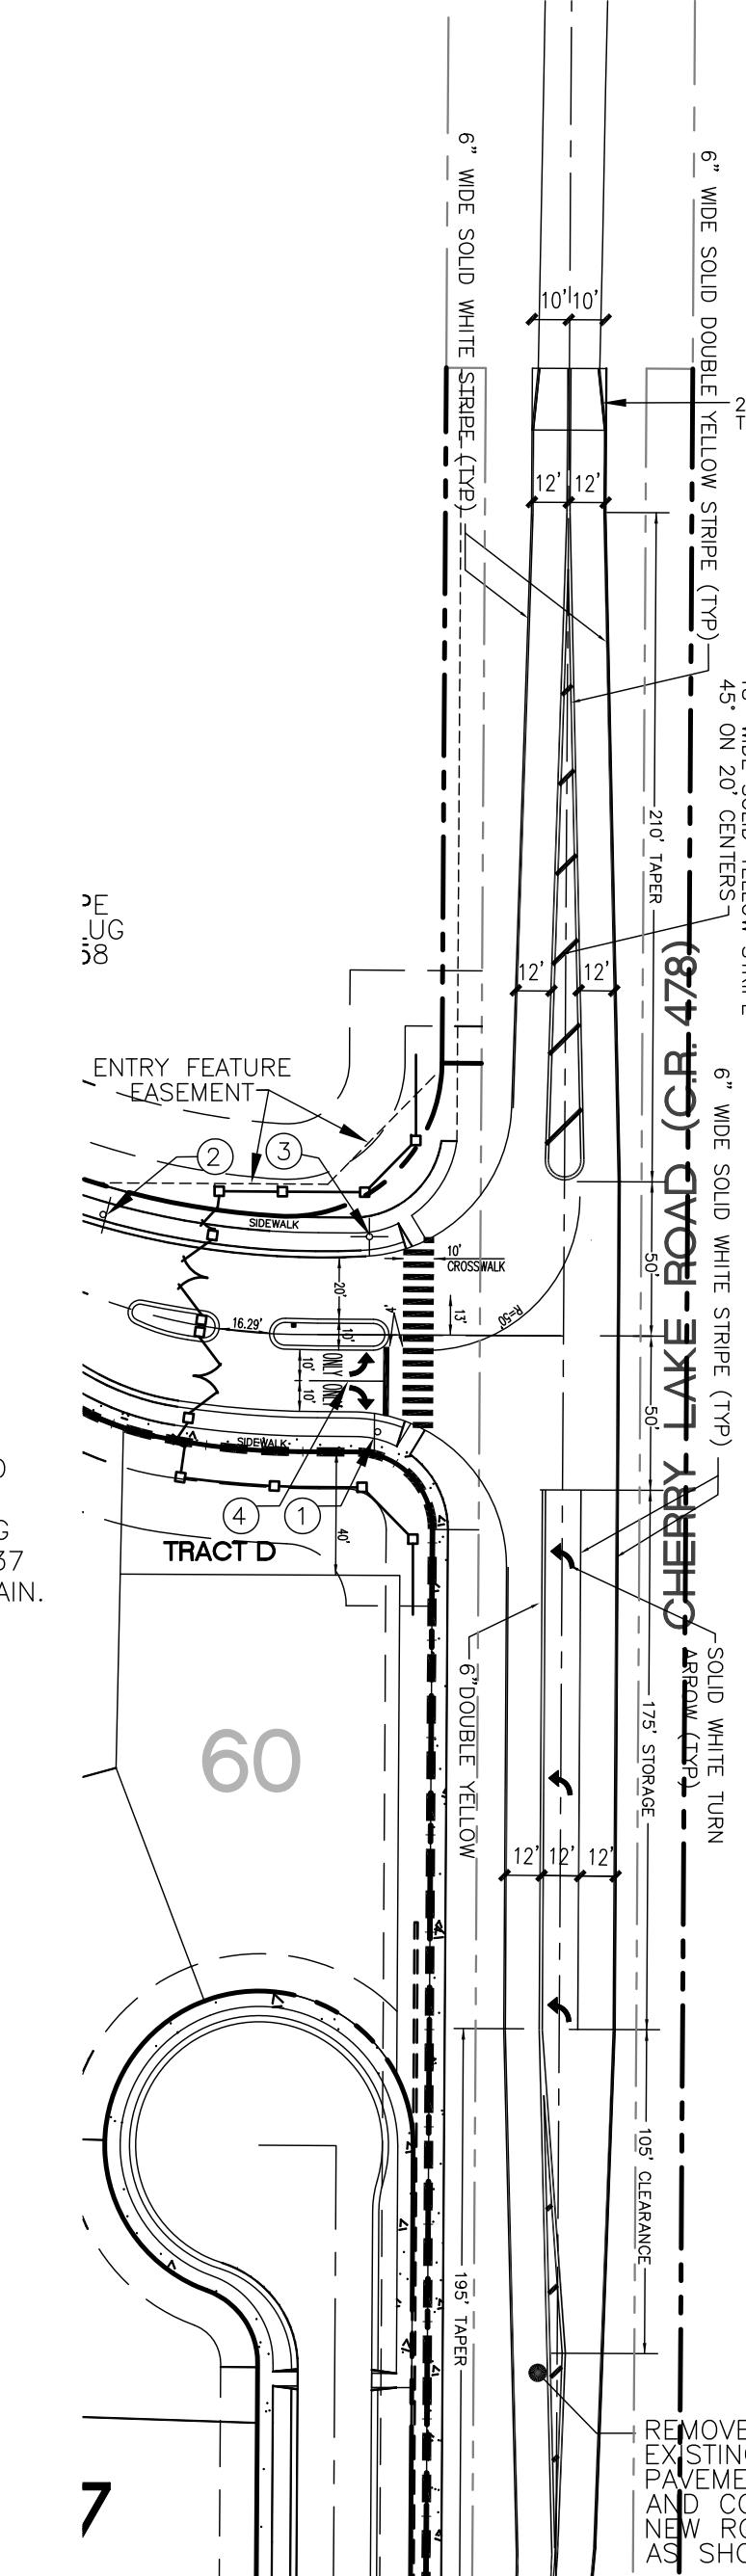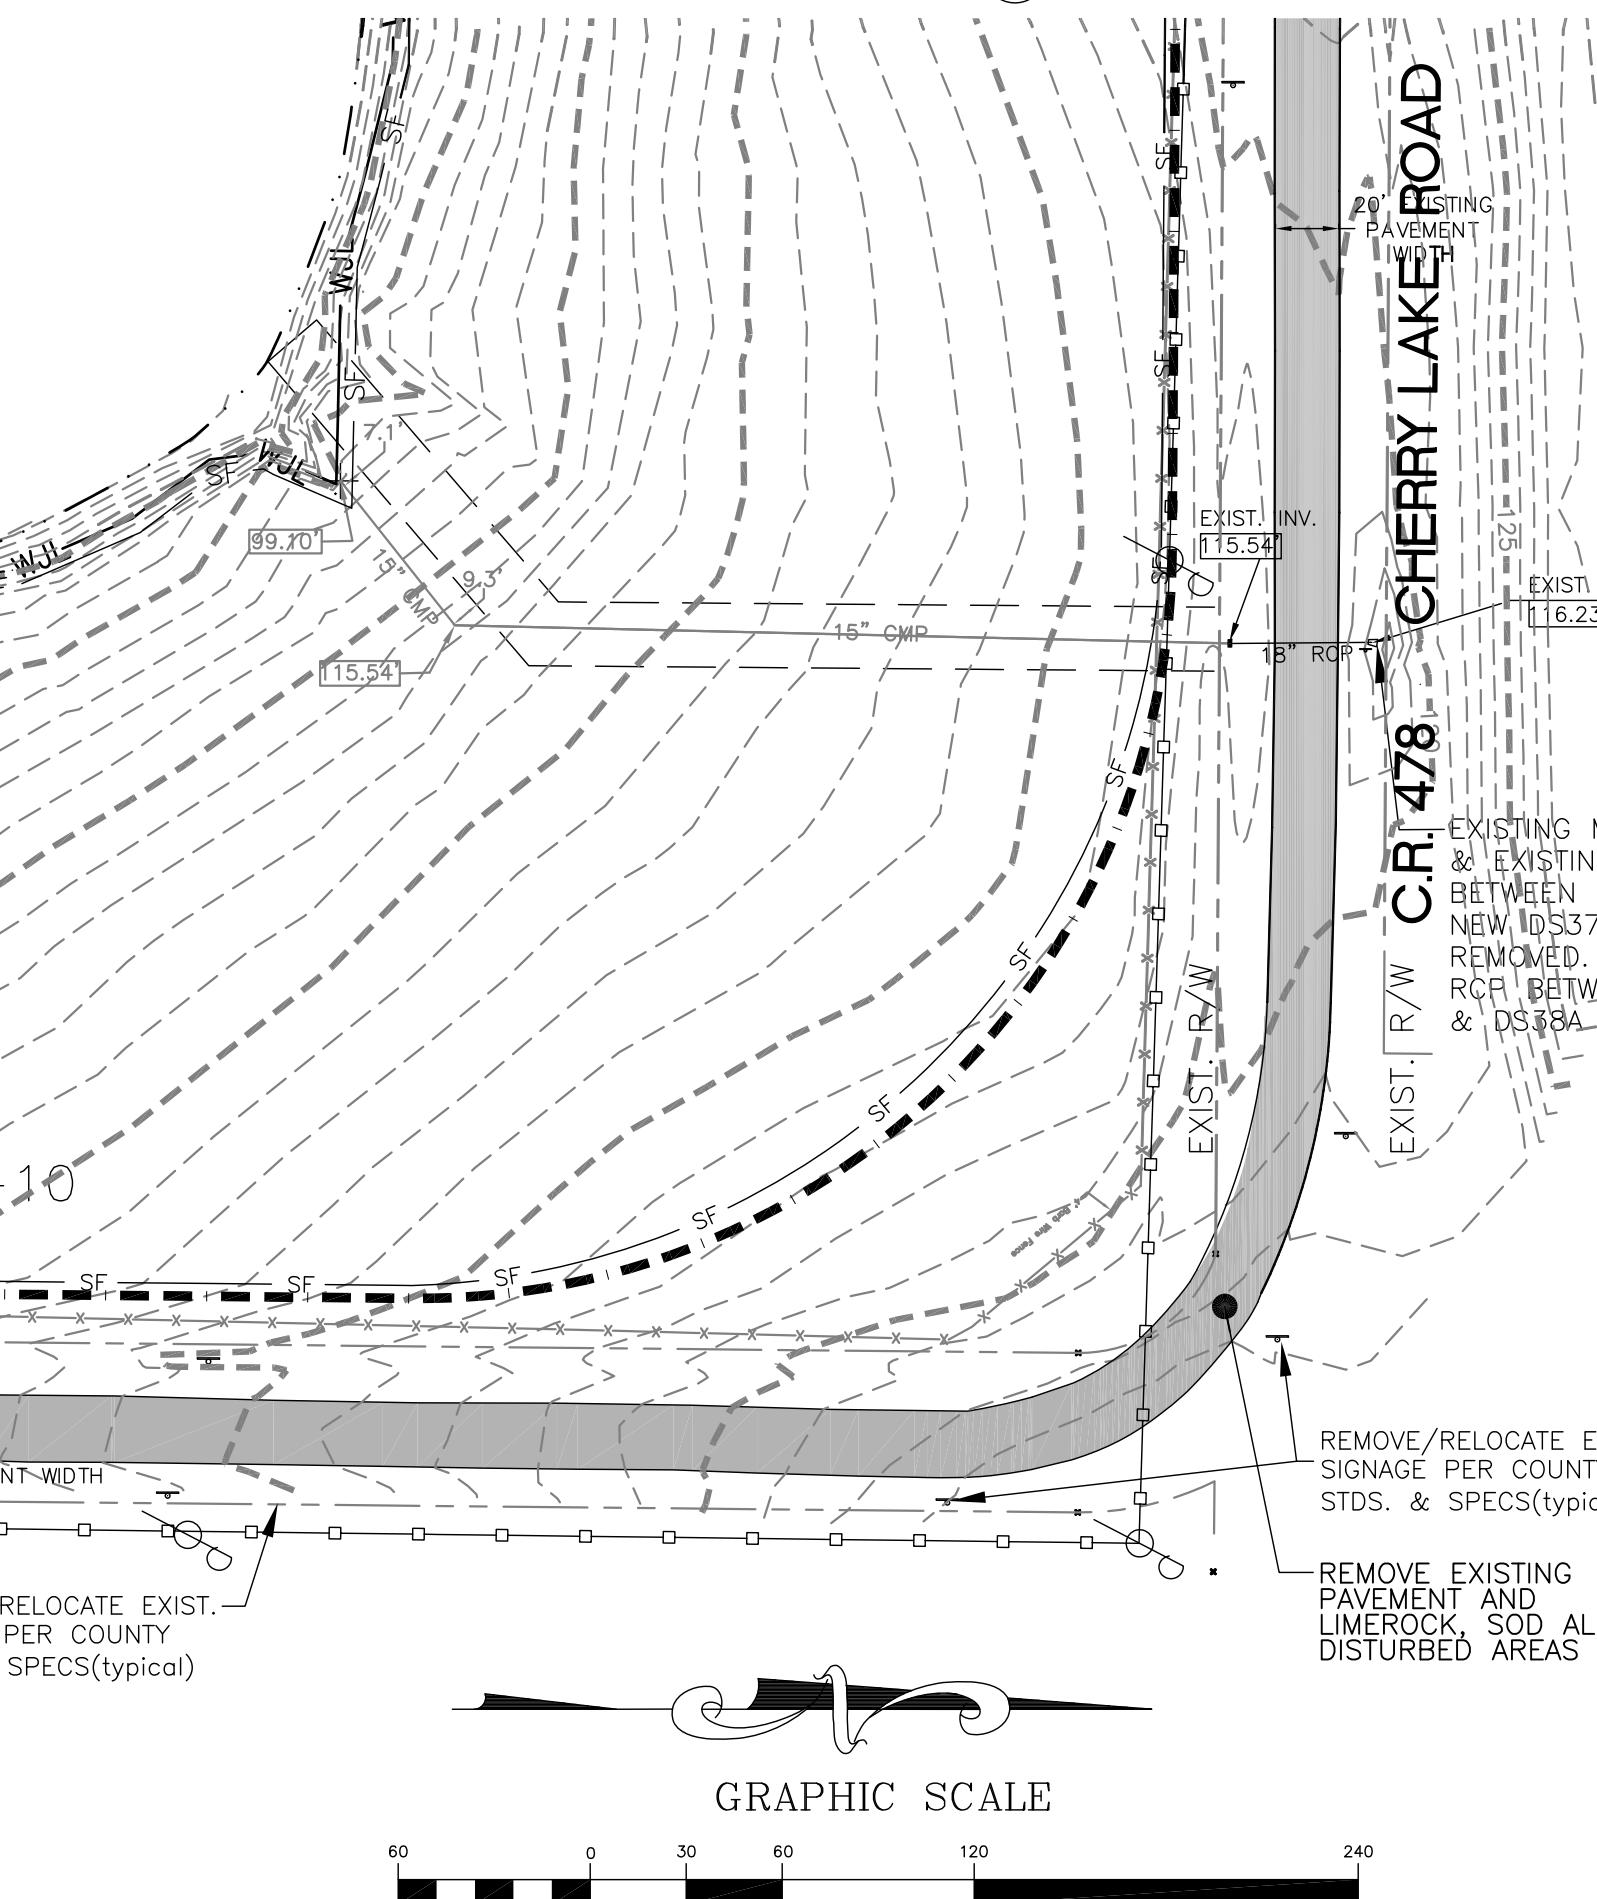

DATE: NOVEMBER 2014
DRAWN BY: TLK
APPROVED BY: TLK
SCALE: NOTED
REVISIONS:

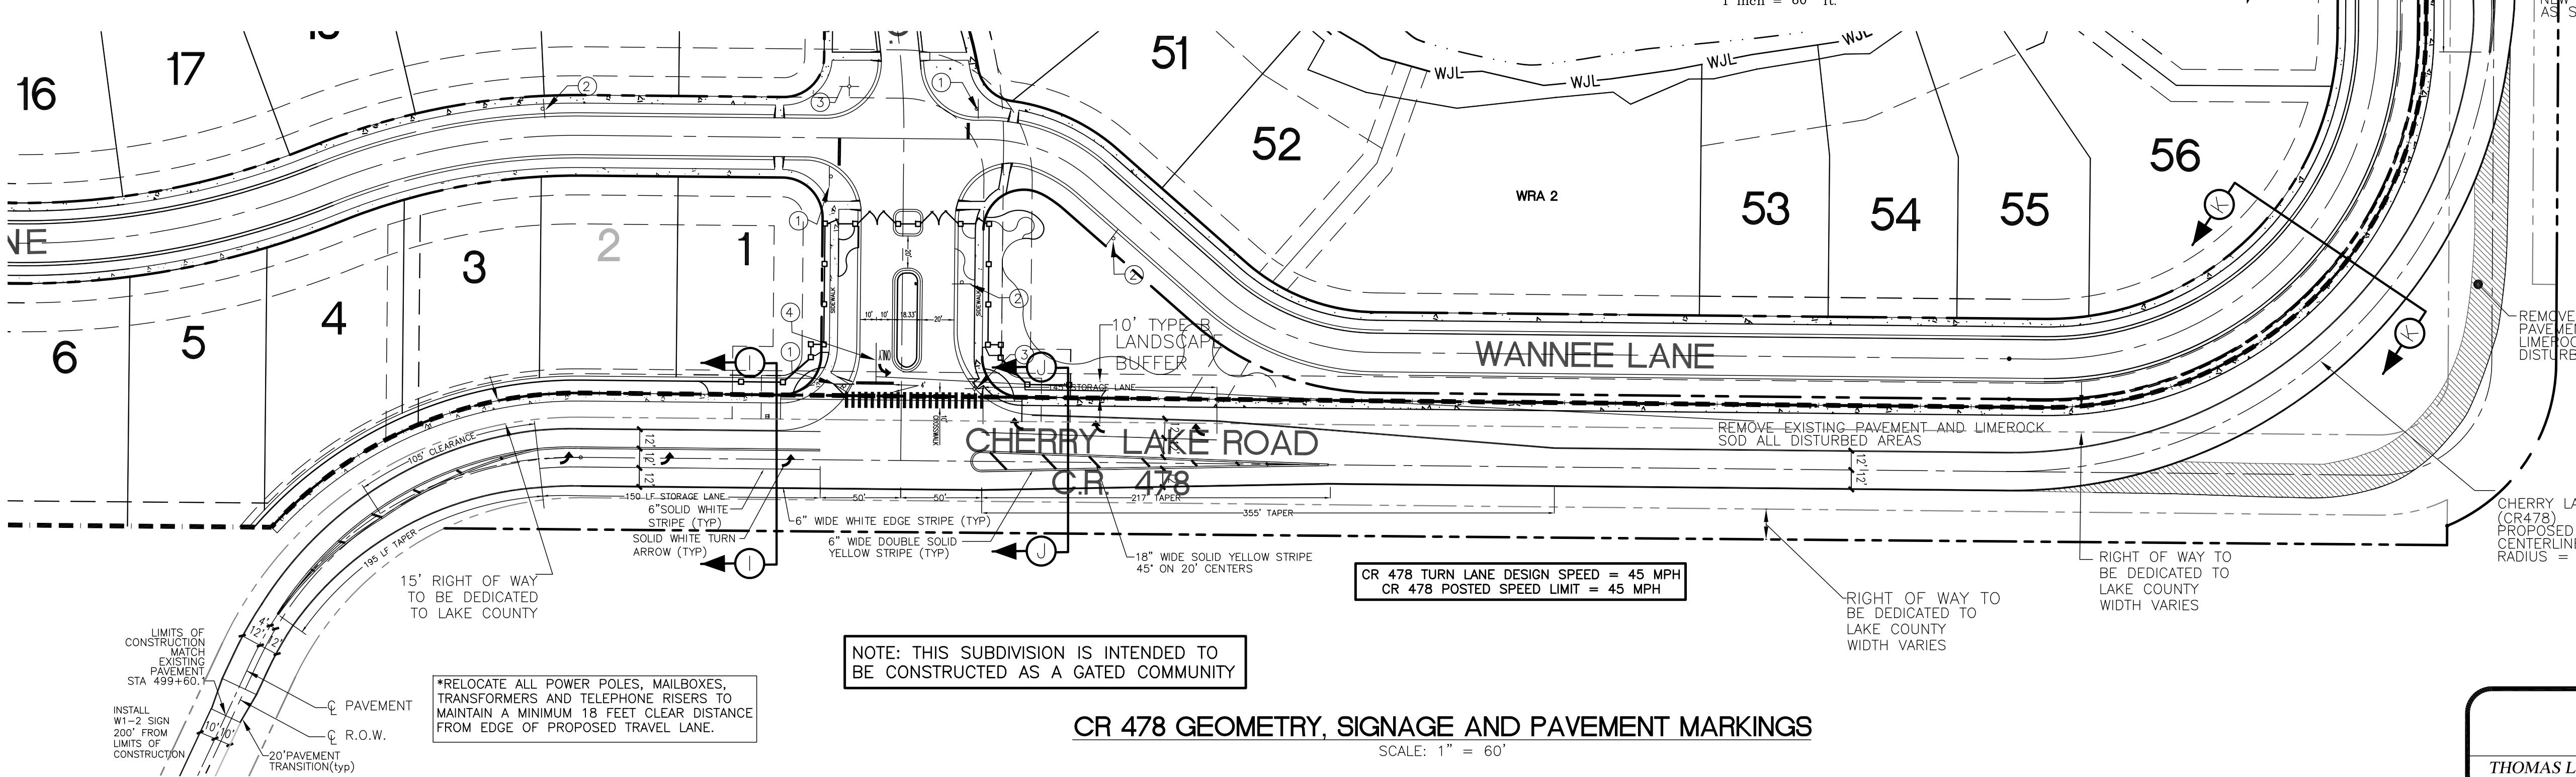

CR 478 GEOMETRY, SIGNAGE AND PAVEMENT MARKINGS

SCALE: 1" = 60'

PRELIMINARY PLAT - FOR REVIEW ONLY - NOT FOR CONSTRUCTION

THOMAS L. KNIGHT
#47614

PROJECT NO. K06-11
C.R 478
ROADWAY
IMPROVEMENTS
1

SHEET: 8 OF 12


SPRINGS AT CHERRY LAKE

SECTION 3; TOWNSHIP 22S; RANGE 25E, CITY OF GROVELAND, FLORIDA
OWNER/DEVELOPER: L&D LLC, ET AL
ADDRESS: P.O. BOX 97, BELL, FL 32619 PHONE: (352) 463-2942

THOMAS L. KNIGHT, P.E.
PROFESSIONAL ASSOCIATION
Planning, Design, Permitting, Inspection
PHONE: (352) 394-8514 FAX: (352) 394-8541
Certificate of Authorization No. 00029372

SPRINGS AT CHERRY LAKE


SECTION 3; TOWNSHIP 22S; RANGE 25E, CITY OF GROVELAND, FLORIDA
OWNER/DEVELOPER: L&D LLC, ET AL
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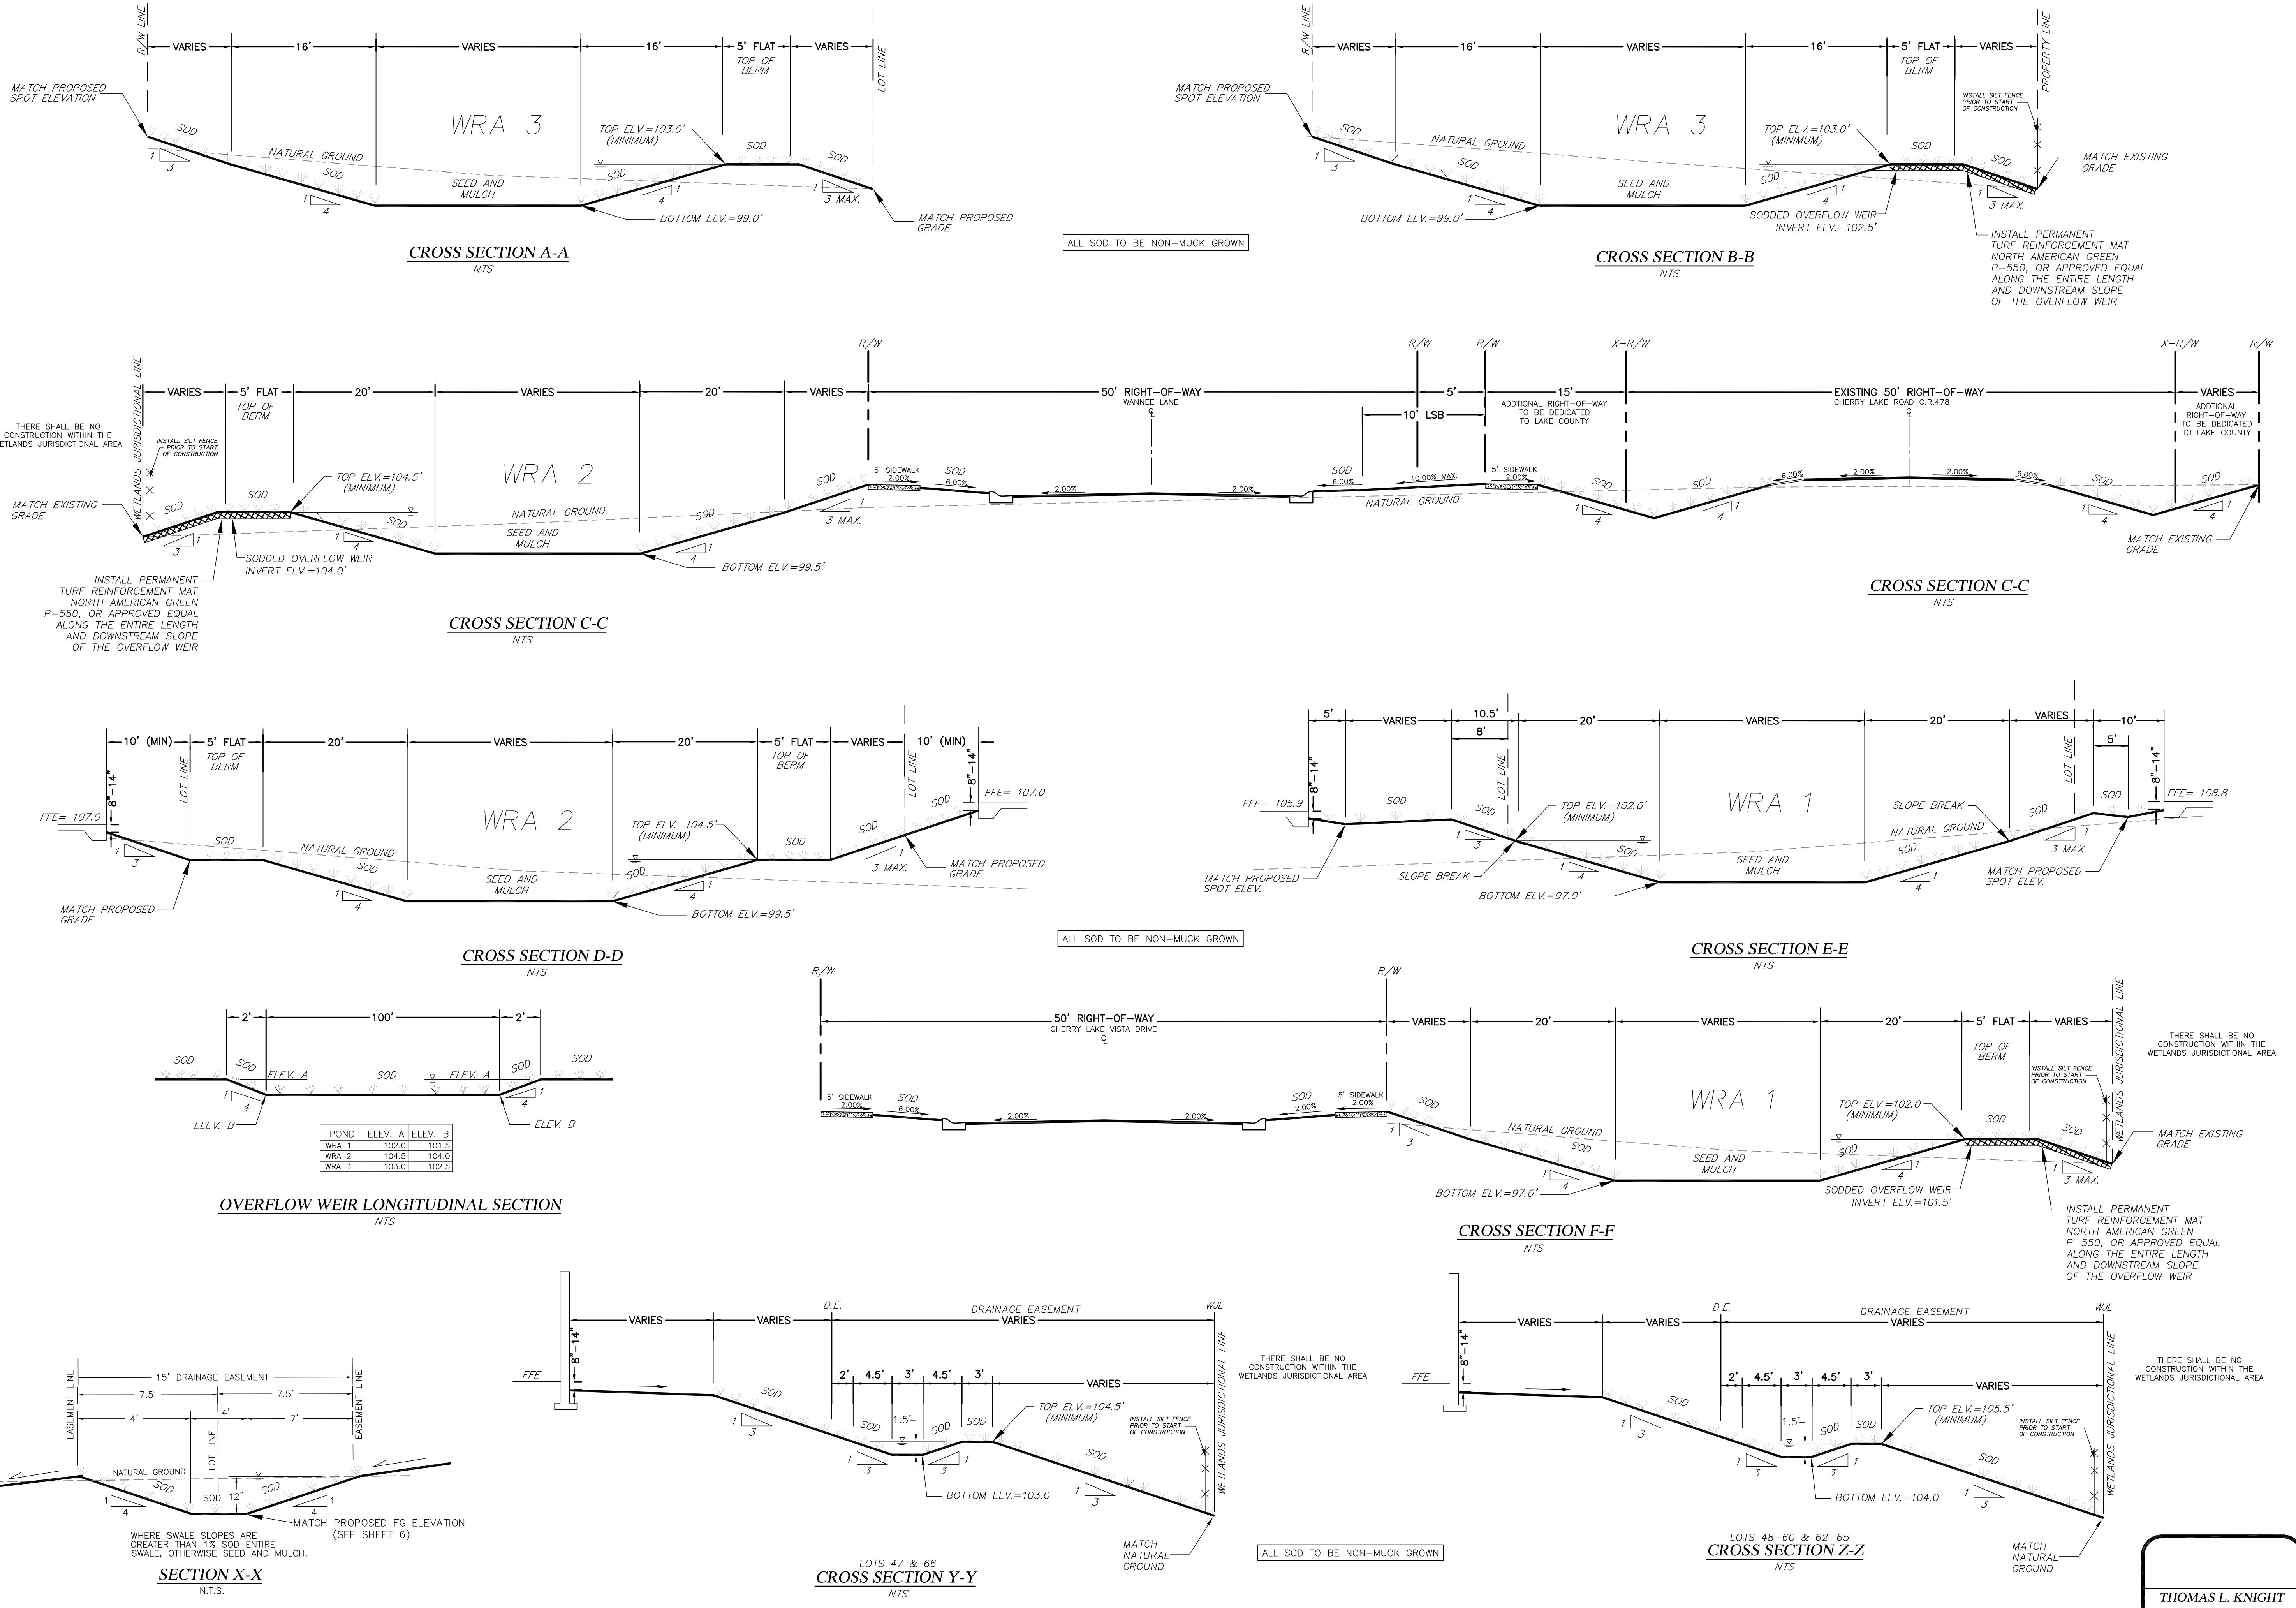
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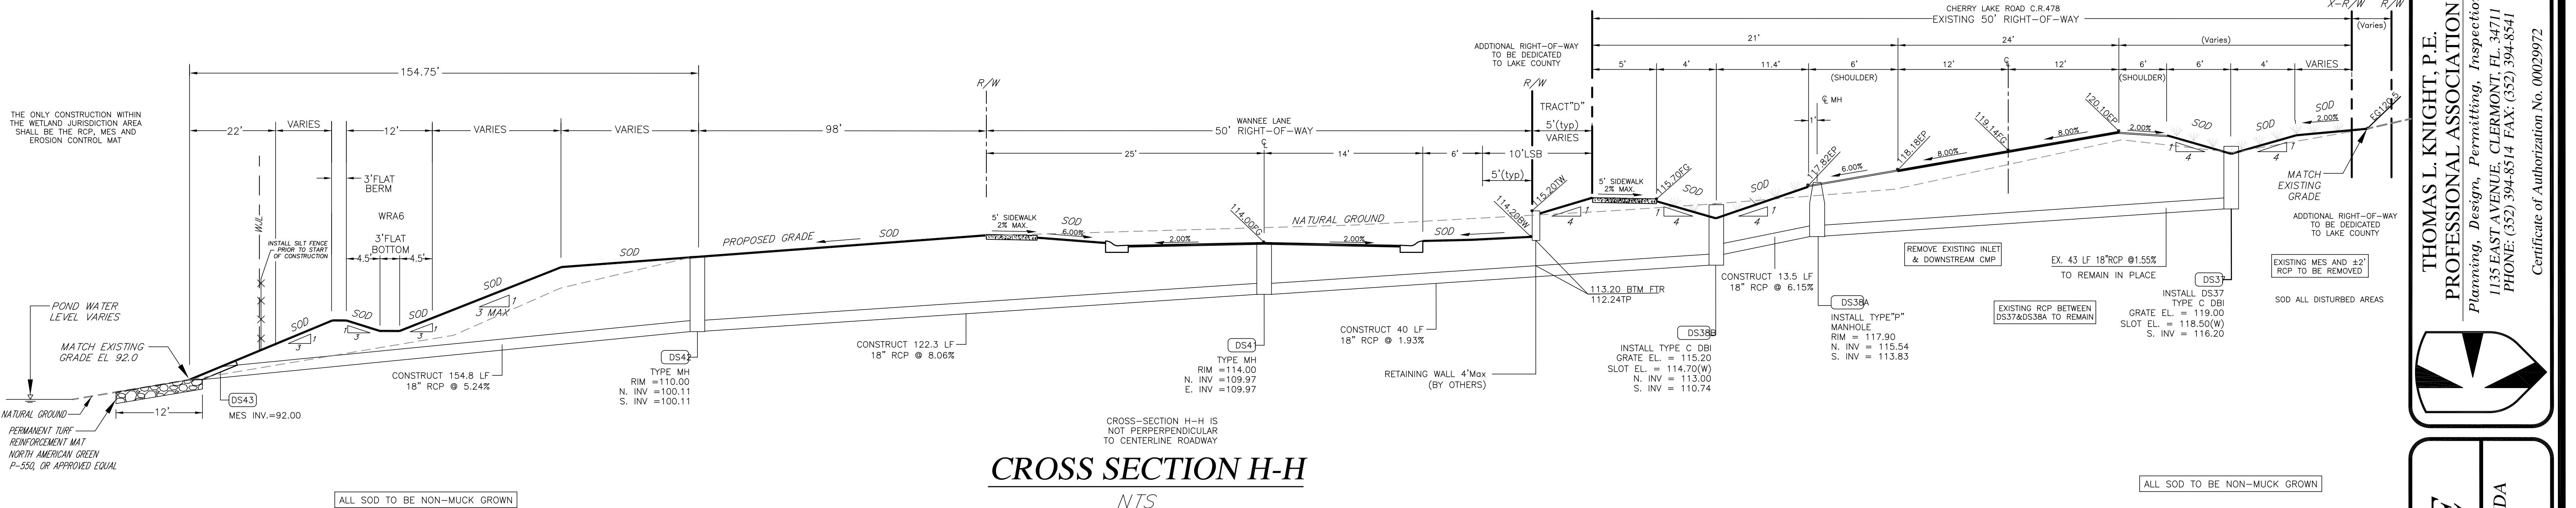
PROFESSIONAL ASSOCIATION

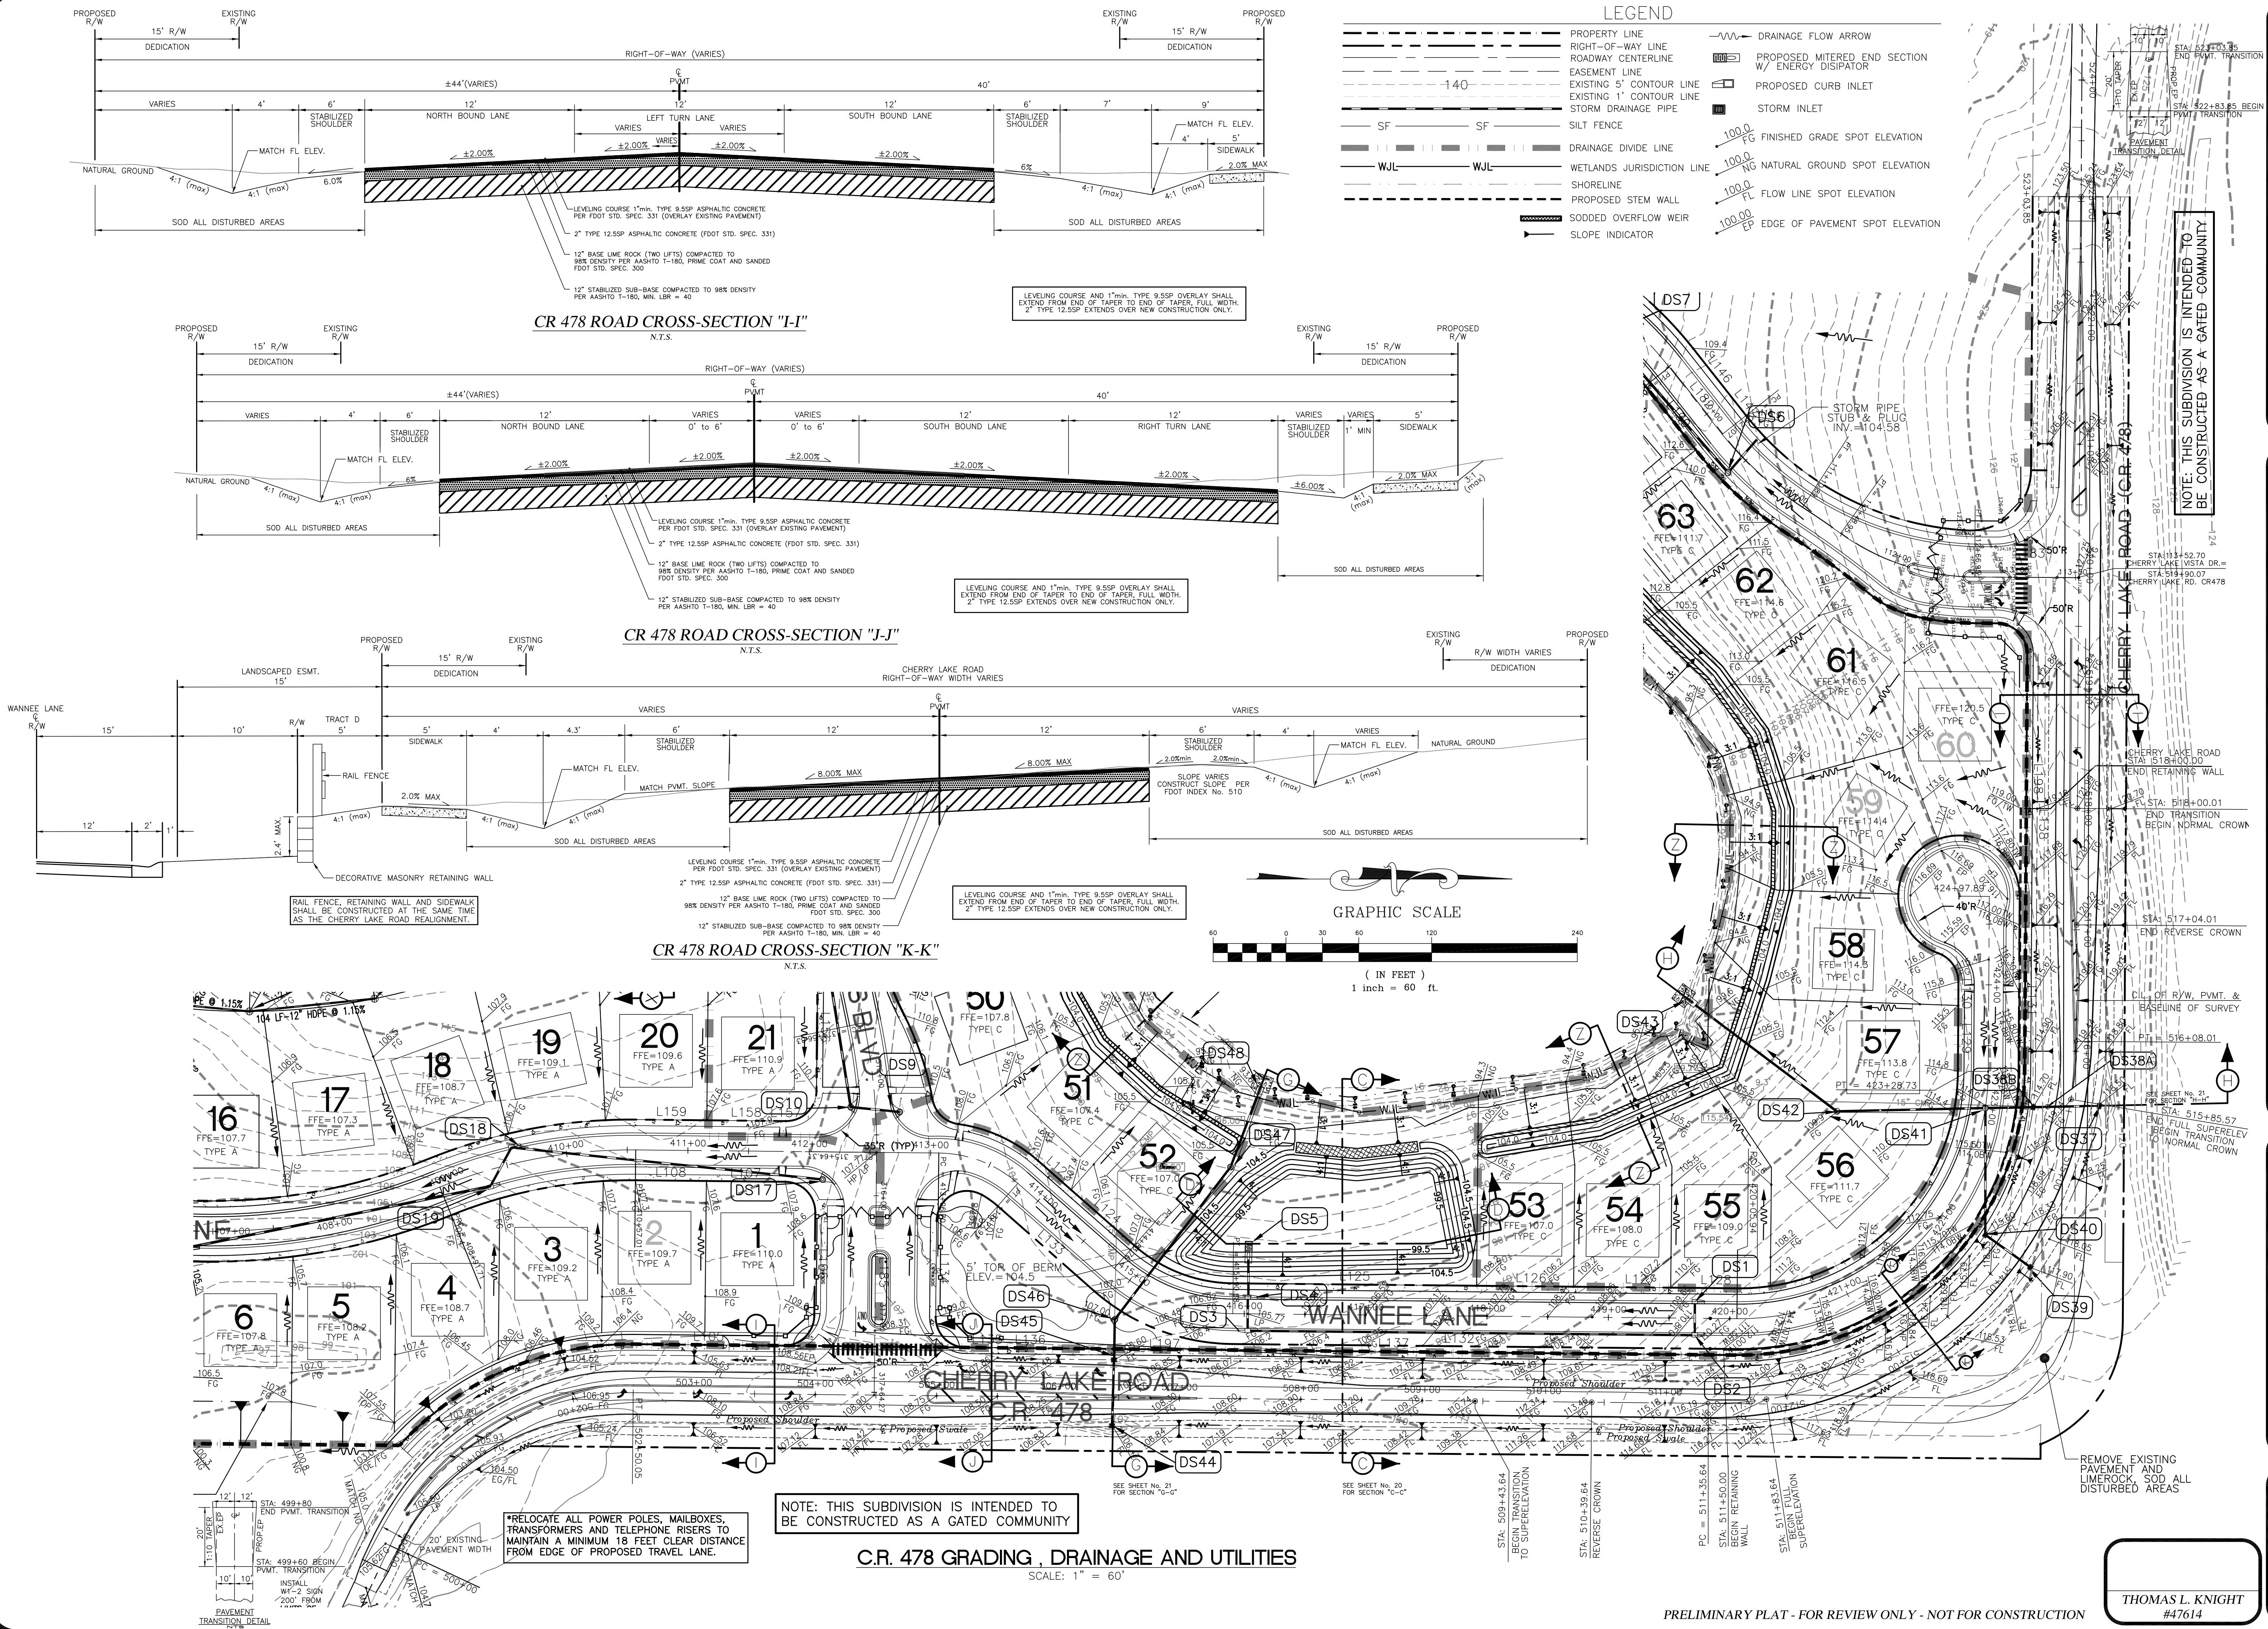Planning, Design, Permitting, Inspection

Certificate of Authorization No. 00029972




PRELIMINARY PLAT - FOR REVIEW ONLY - NOT FOR CONSTRUCTION

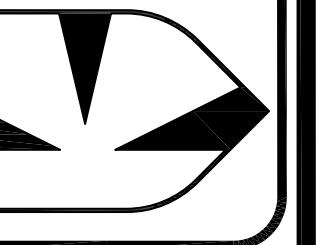



CROSS SECTION H-H

NTS

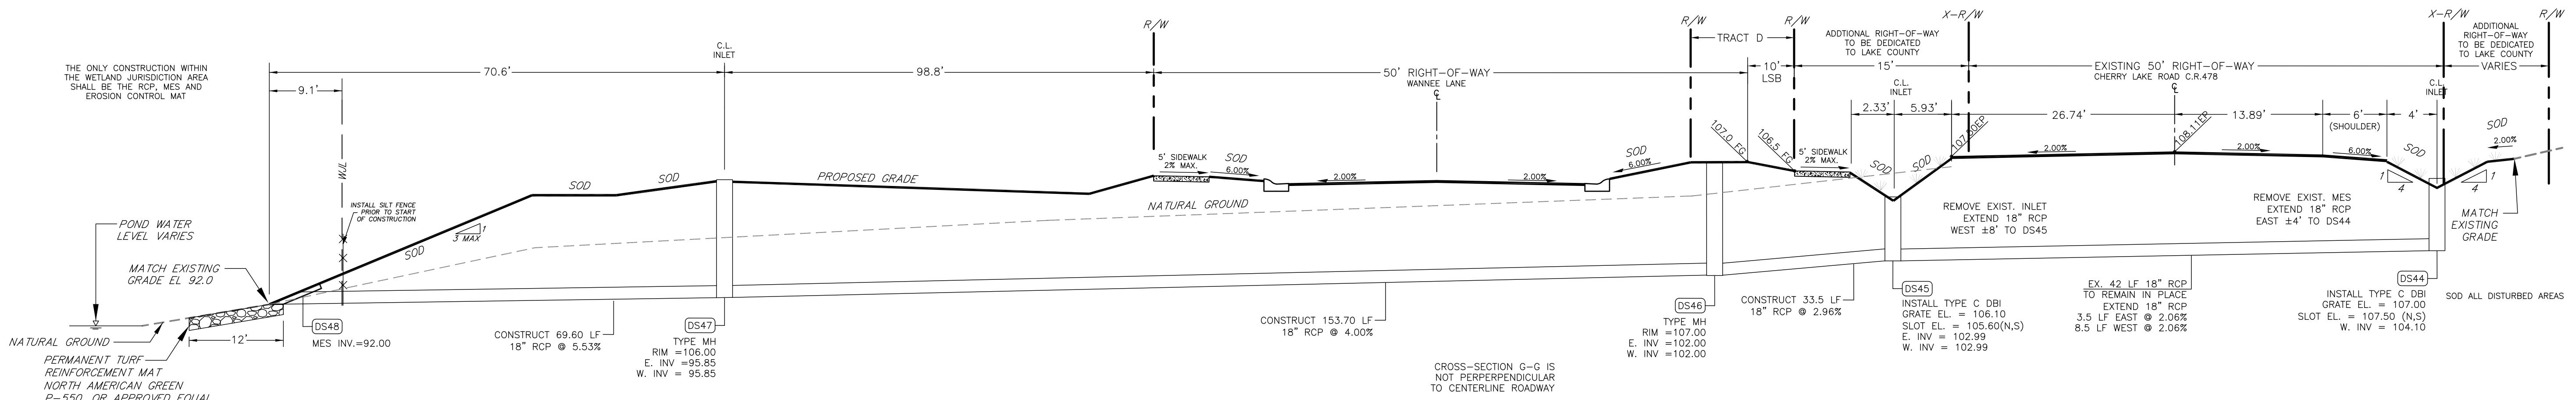

CROSS SECTION G-G

NTS

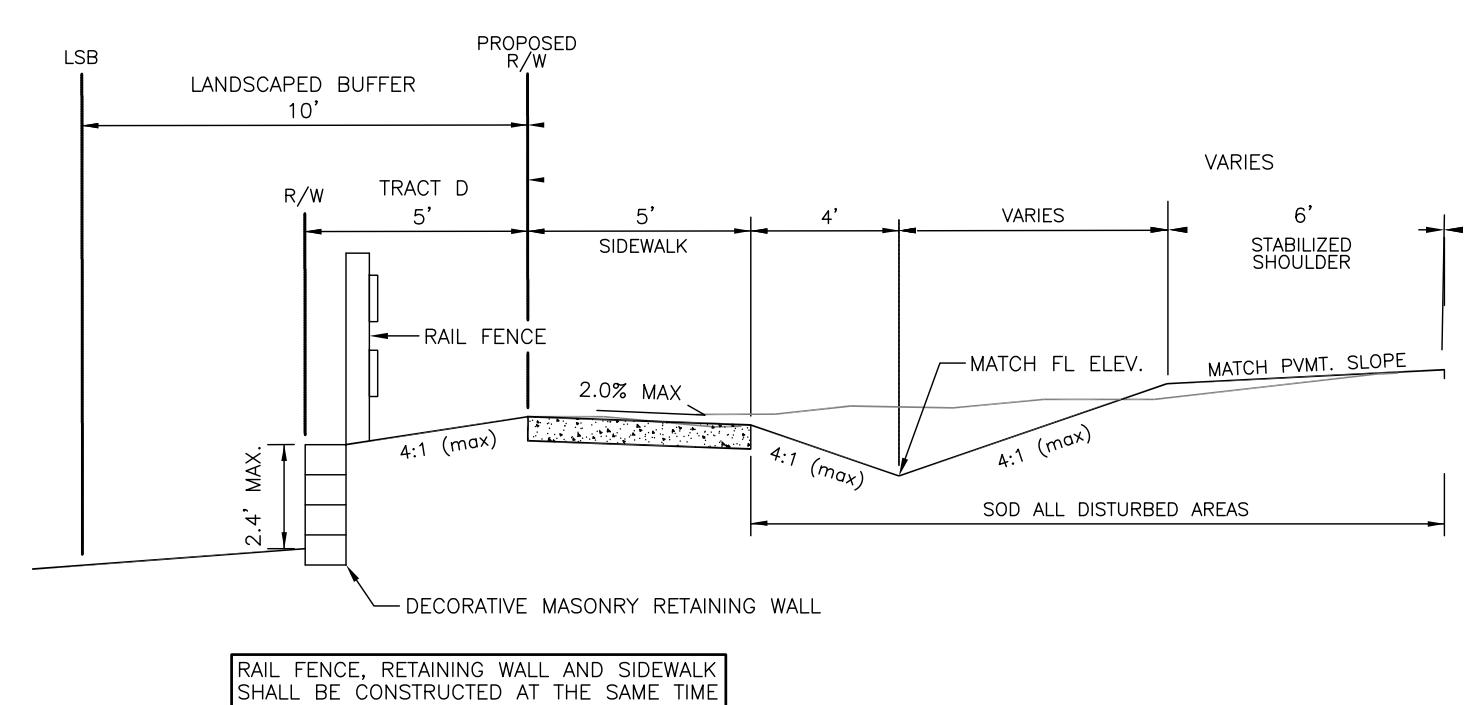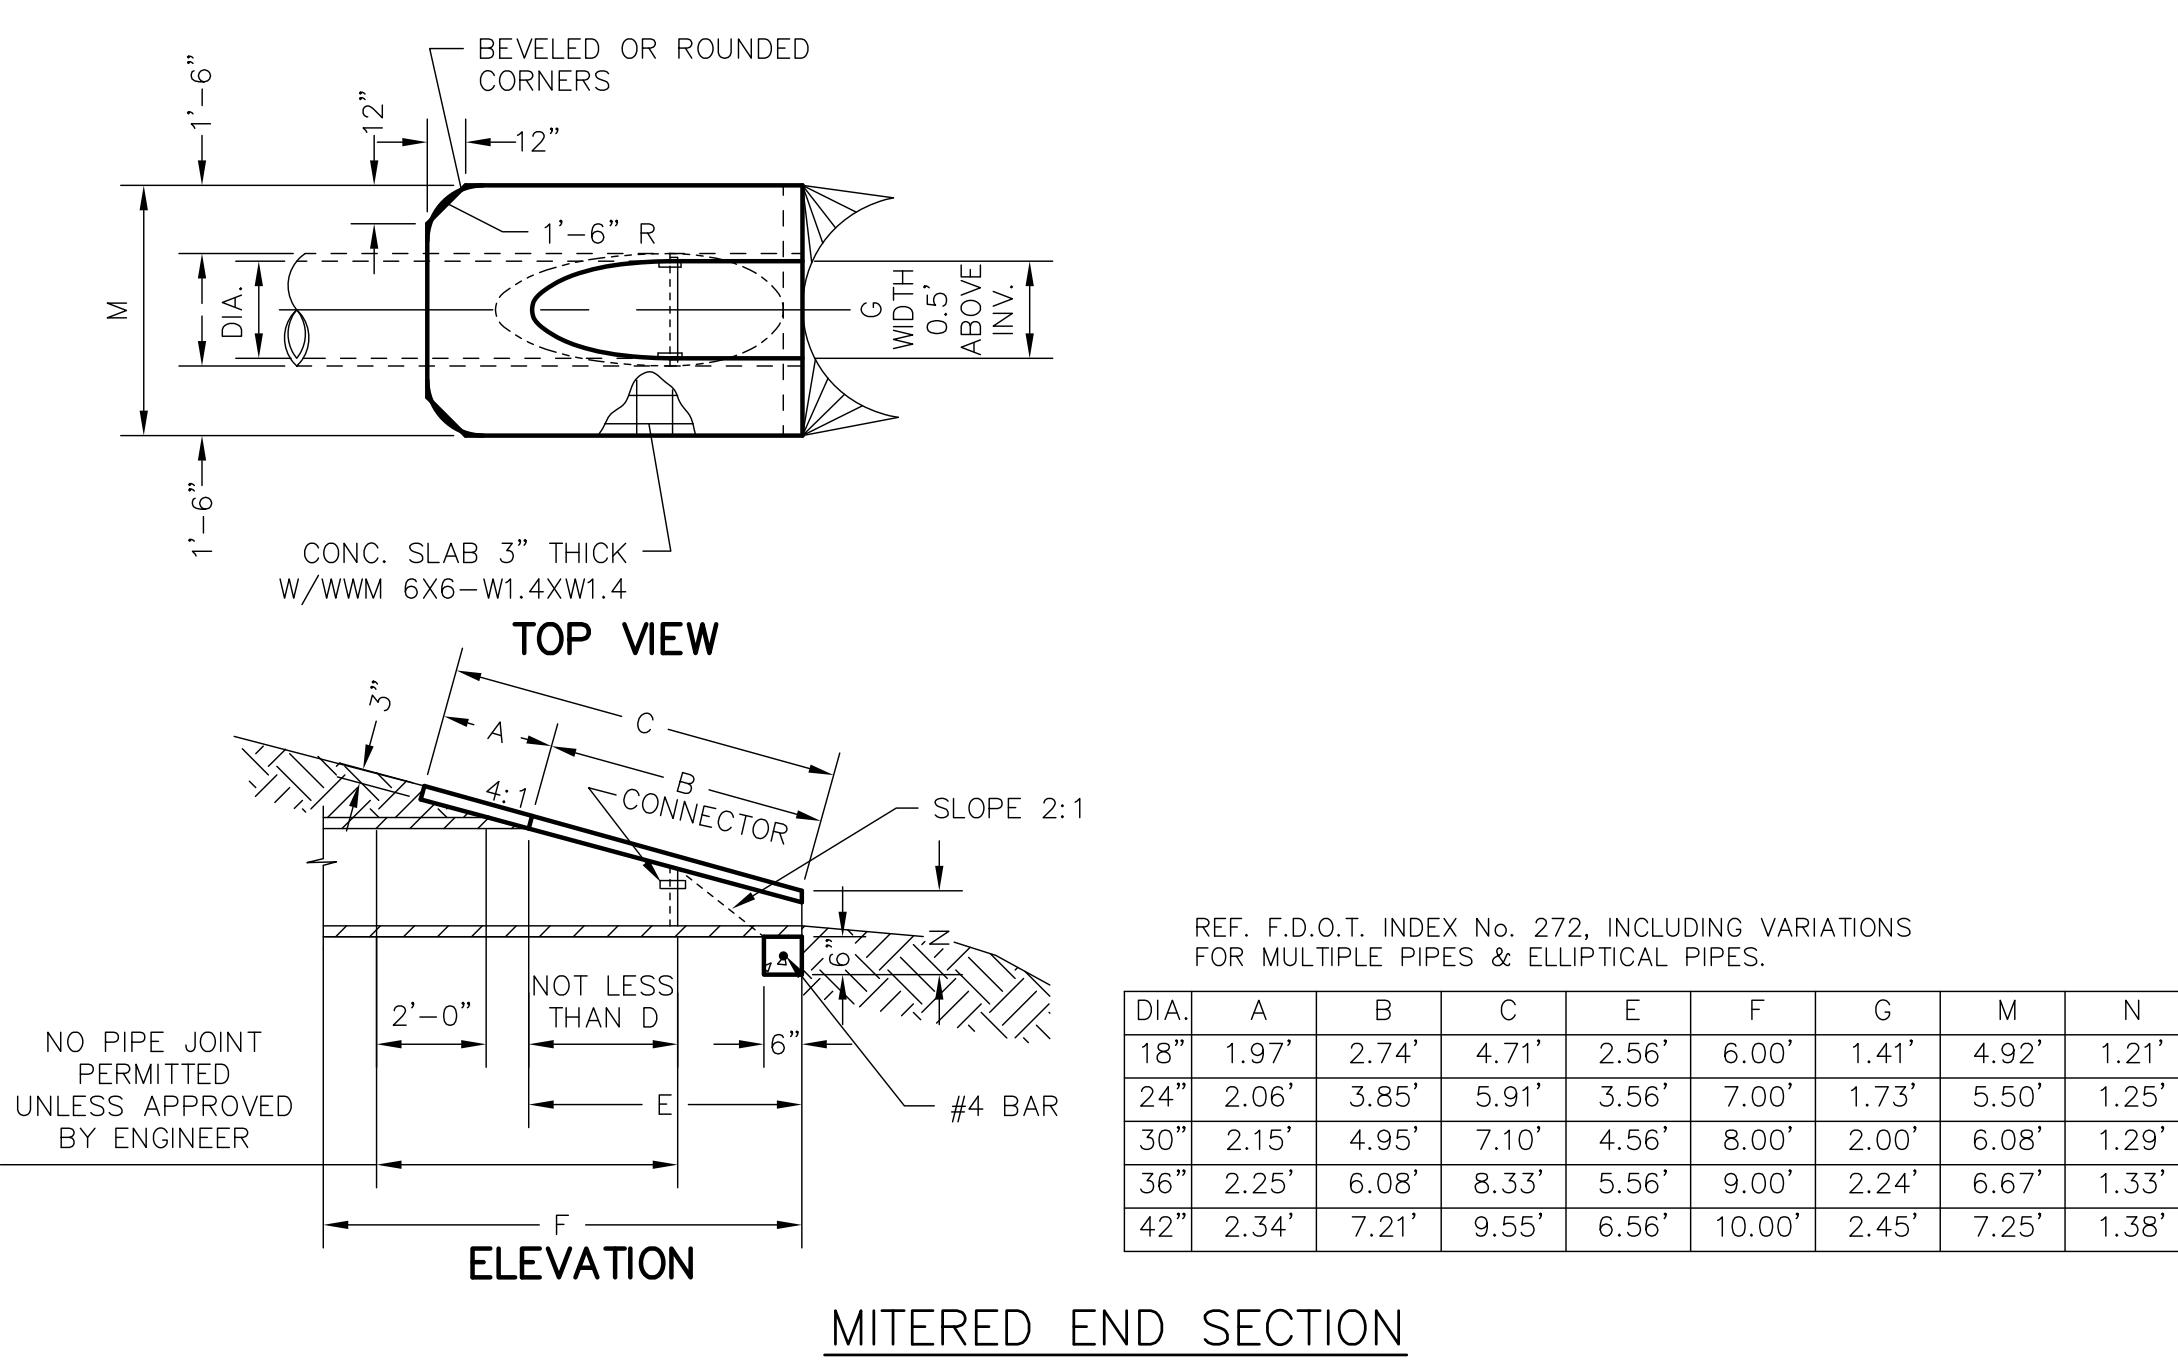

RAIL FENCE, RETAINING WALL AND SIDEWALK
SHALL BE CONSTRUCTED AT THE SAME TIME

DATE:
NOVEMBER 2014

DRAWN BY:
TLK

APPROVED BY:
TLK

SCALE:
NONE

REVISIONS:

PROJECT NO.
K06-11

*TYPICAL
CROSS-SECTIONS*

